47'-6"

11'-111/4"

33'-6"

BATH

9' CEILING  $\stackrel{*}{\sim}$ 

BOILER (W.H.)

10'-3"

COVERED ENTRY

2'-7¼" 3'-5¼"

6'-0½"

11'-7"

009 PR 3'-0"x6'-8"

19'-11"

9' CEILING

2 CAR GARAGE

20'-6"

20'-6"

5'-11½"

12'-5½"

9' CEILING BDRM #3

9' CEILING

BDRM #2

10'-1"

9 5'-0'X2'-0'

DOOR AND

FRAME

SCHEDULE

3'-0"

3'-0"

2'-6"

2'-6"

2'-6"

2'-6"

2'-6"

2'-6"

3'-0"

16'-0"

1'-0"

5'-0"

5'-0"

5'-0"

4'-0"

2'-0"

SQUARE FOOTAGE

TABLE

MARK

001

002

003

004

005

007

009

010

012

013

014

015

016

017

5'-0"

3'-0"

3'-0"

6'-0"

5'-0"

5'-0"

003

004

800

009

GARAGE SF

LIVING SPACE

WINDOW SCHEDULE

DOOR

8'-0"

8'-0"

6'-8"

6'-8" 6'-8"

8'-0"

6'-8"

Style

Picture

Double

Hung Double

Hung

Glider

Glider

Glider

Glider

Picture

AREA

442.63 SF

1574.53 SF

DRAWN BY
<i>ALLDRAFT</i>
FILE NAME
CAD FILE
DATE
6-26-202
SCALE
1/4" = 1'-
SHEET
<b>A</b> 1

6X6 POST PER BUILDER 2 PLACES 9' CEILING COVERED DECK 5'-10½" 008 PR 3'-0"x8'-0" 27'-0" DINING LIVING CARPET CARPET 9' CEILING
KITCHEN TILE 003) 2'-6"x8'-0" M. BATH 9' CEILING **MASTER BEDROOM** SHOWER SHELVING 9' CEILING W.I.C. CARPET 13'-0" 7'-1" 6'-9½" 10'-4" 3'-10"

20'-11½"


27'-0"

14'-0"

COPY RIGHT NOTICE:
1. THE OWNER AND OR BUILDER AGREE TO OBTIAN A LICENSE FOR ANY COPY RIGHTED MATERIAL THAT
MAY HAVE BEEN PROVIDED TO ALLDRAFT FOR THE CREATION OF THIS PLAN PRIOR TO CONSTRUCTION.
2. THE OWNER AND OR BUILDER AGREE TO RESEARCH AND VERIFY THE LEGALITY OF ALL COPY RIGHT
OWNERSHIPS FOR ALL MATERIALS THAT THEY HAVE PROVIDED TO ALLDRAFT.
3. THE OWNER AND OR BUILDER AGREE THAT ALLDRAFT IS NOT RESPONSIBLE FOR OBTAINING ANY
COPY RIGHT LICENSE AND AGREE TO HOLD HARMLESS, DEFEND AND INDEMNIFY ALLDRAFT FROM


# ANY AND ALL LEGAL ACTIONS THAT MAY RESULT FROM THE CREATION OF THESE PLANS. 4. USE OF THIS PLAN CONSTITUES ACCEPTANCE OF THESE TERMS BY THE OWNER AND OR BUILDER.


10'-3"

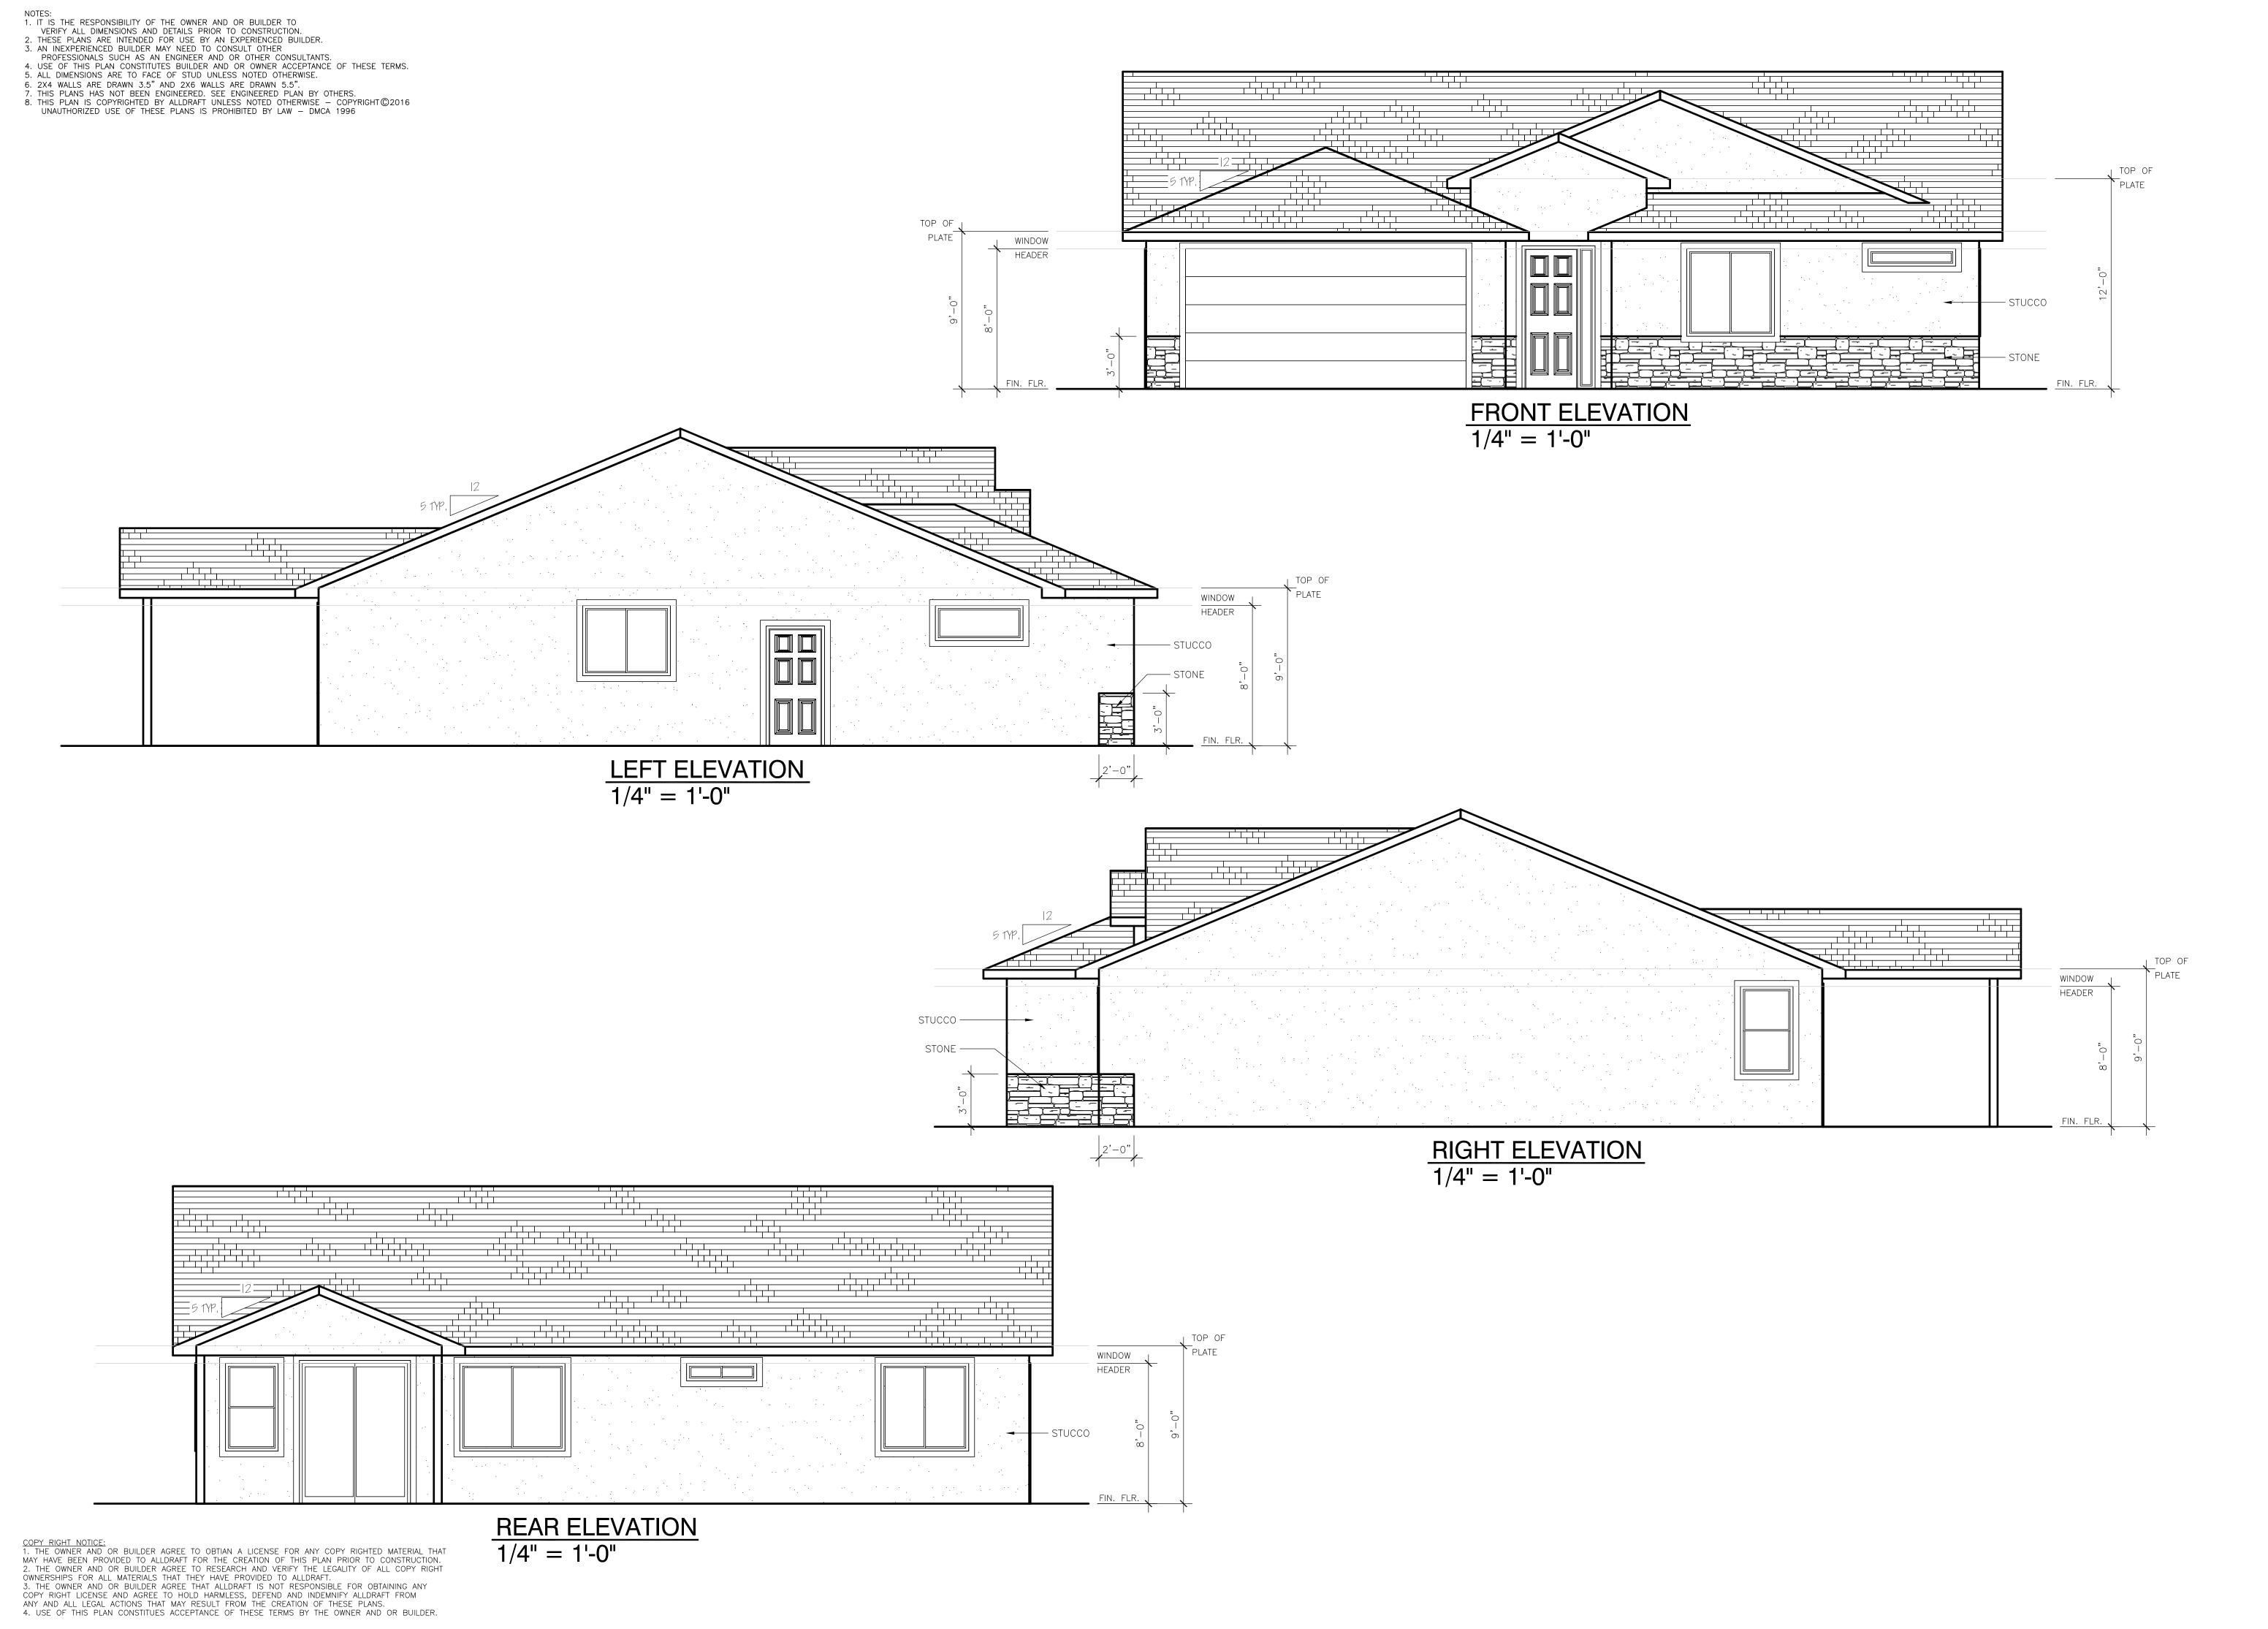

REVISIONS

A
B
C
D
E
F
G
H

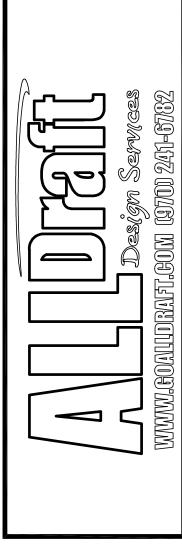

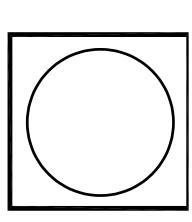

ASPEN LEAF ININOWATION: 2507 ARABESQUE

DRAWN BY

ALLDRAFT

FILE NAME

CAD FILE

DATE

6-26-2020

SCALE

1/4" = 1'-0"

SHEET

NOTES:

1. IT IS THE RESPONSIBILITY OF THE OWNER AND OR BUILDER TO VERIFY ALL DIMENSIONS AND DETAILS PRIOR TO CONSTRUCTION.

2. THESE PLANS ARE INTENDED FOR USE BY AN EXPERIENCED BUILDER.


3. AN INEXPERIENCED BUILDER MAY NEED TO CONSULT OTHER PROFESSIONALS SUCH AS AN ENGINEER AND OR OTHER CONSULTANTS.


4. USE OF THIS PLAN CONSTITUTES BUILDER AND OR OWNER ACCEPTANCE OF THESE TERMS.


5. ALL DIMENSIONS ARE TO FACE OF STUD UNLESS NOTED OTHERWISE.

6. 2X4 WALLS ARE DRAWN 3.5" AND 2X6 WALLS ARE DRAWN 5.5".

7. THIS PLANS HAS NOT BEEN ENGINEERED. SEE ENGINEERED PLAN BY OTHERS. 8. THIS PLAN IS COPYRIGHTED BY ALLDRAFT UNLESS NOTED OTHERWISE - COPYRIGHT @ 2016 UNAUTHORIZED USE OF THESE PLANS IS PROHIBITED BY LAW - DMCA 1996

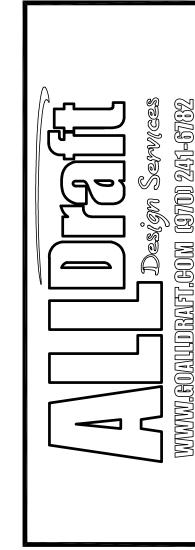

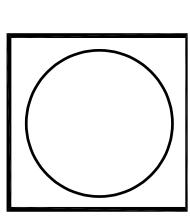

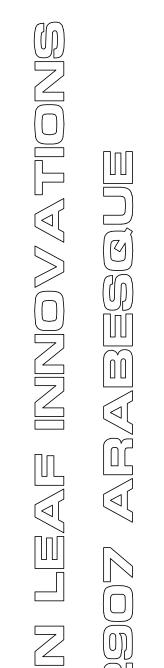

- R=38 INSULATION MIN.

W/ CLIPS

FASCIA

- SOFFIT

STUCCO PER BUILDER'S SPECS.

R=13 INSULATION

TYP. MONO SLAB SECTION

— 2X4 STUDS @ 16" O.C.

- 1/2" GYPSUM WALL BOARD

-1/2" ANCHOR BOLTS @ 48" O.C.

MONOLITHIC SLAB FOUNDATION
 PER LOCAL CODE OR ENGINEERED
 BY OTHERS

- WALL SHEATHING PER BUILDER'S SPECS.

SCALE: 1/2" = 1'-0"

ENGINEERED TRUSSES @ 2' O.C.

7/16" OSB ROOF SHEATHING

SCISSOR TRUSSES @ VAULTED AREAS

30 YEAR ARCHITECTURAL SHINGLES & 30# FELT

DRAWN BY ALLDRAFT CAD FILE 6-26-2020 1/4" = 1'-0"

**A3** 

DOOR AND WINDOW HEADER SCHEDULE

OPENING WIDTH (2) 2X8 HEM-FIR (2) 2X8 HEM-FIR (2) 2X12 HEM-FIR (3) 2X12 HEM-FIR (3) 2X12 HEM-FIR (2)  $1 - \frac{3}{4} \times 11 - \frac{7}{8}$  ML (2)  $1 - \frac{3}{4} \times 11 - \frac{7}{8}$  ML (2)  $1 - \frac{3}{4} \times 11 - \frac{7}{8}$  ML

HEADERS BELOW A GIRDER TRUSS OR BELOW ANY ADDITIONAL POINT LOAD SHOULD BE REVIEWED BY AN ENGINEER.

BASEMENTS IN DWELLING UNITS AND EVERY SLEEPING ROOM BELOW THE FOURTH STORY MUST HAVE ONE OPERABLE WINDOW

OR EXTERIOR DOOR APPROVED FOR ESCAPE OR RESCUE.

ESCAPE OR RESCUE WINDOWS SHALL HAVE A MINIMUM NET CLEAR OPENING OF 5.7 SQUARE FEET. MINIMUM NET

OPENING HEIGHT IS 24 INCHES. THE MINIMUM NET CLEAR OPENING WIDTH IS 20". THE MAXIMUM SILL HEIGHT IS 44 INCHES FROM THE FLOOR.

VENTILATION AND LIGHTING NOTES: ALL ROOMS MUST MEET MINIMUM VENTILATION AND LIGHTING REQUIREMENTS. VENTILATION - .04% PER SQUARE FOOT LIGHTING - .08% PER SQUARE FOOT


EGRESS STANDARDS ALSO APPLY


EXTERIOR WALL PLUMBING NOTES: NO P TRAPS, WATER OR HEAT LINES ALLOWED IN OUTSIDE WALLS, WALLS COMMON TO GARAGE OR CEILINGS UNLESS DEEP ENOUGH OR IF HEATED.

ATTIC SPACE IS CONSIDERED TO BE AN OUTSIDE WALL.

**GARAGE NOTES:** 

NEED 12" GYP-BOARD ON GARAGE SIDE OF SEPARATION BETWEEN HOUSE AND GARAGE. EQUALLY PROTECT WALLS AND MEMBERS SUPPORTING SEPARATION. NEED %" TYPE "X" GYP-BOARD ON CELINGS OF GARAGES WITH HABITABLE SPACE ABOVE. DOORS IN SEPARATION WALLS MUST BE 1-%" SOLID WOOD OR STEEL.

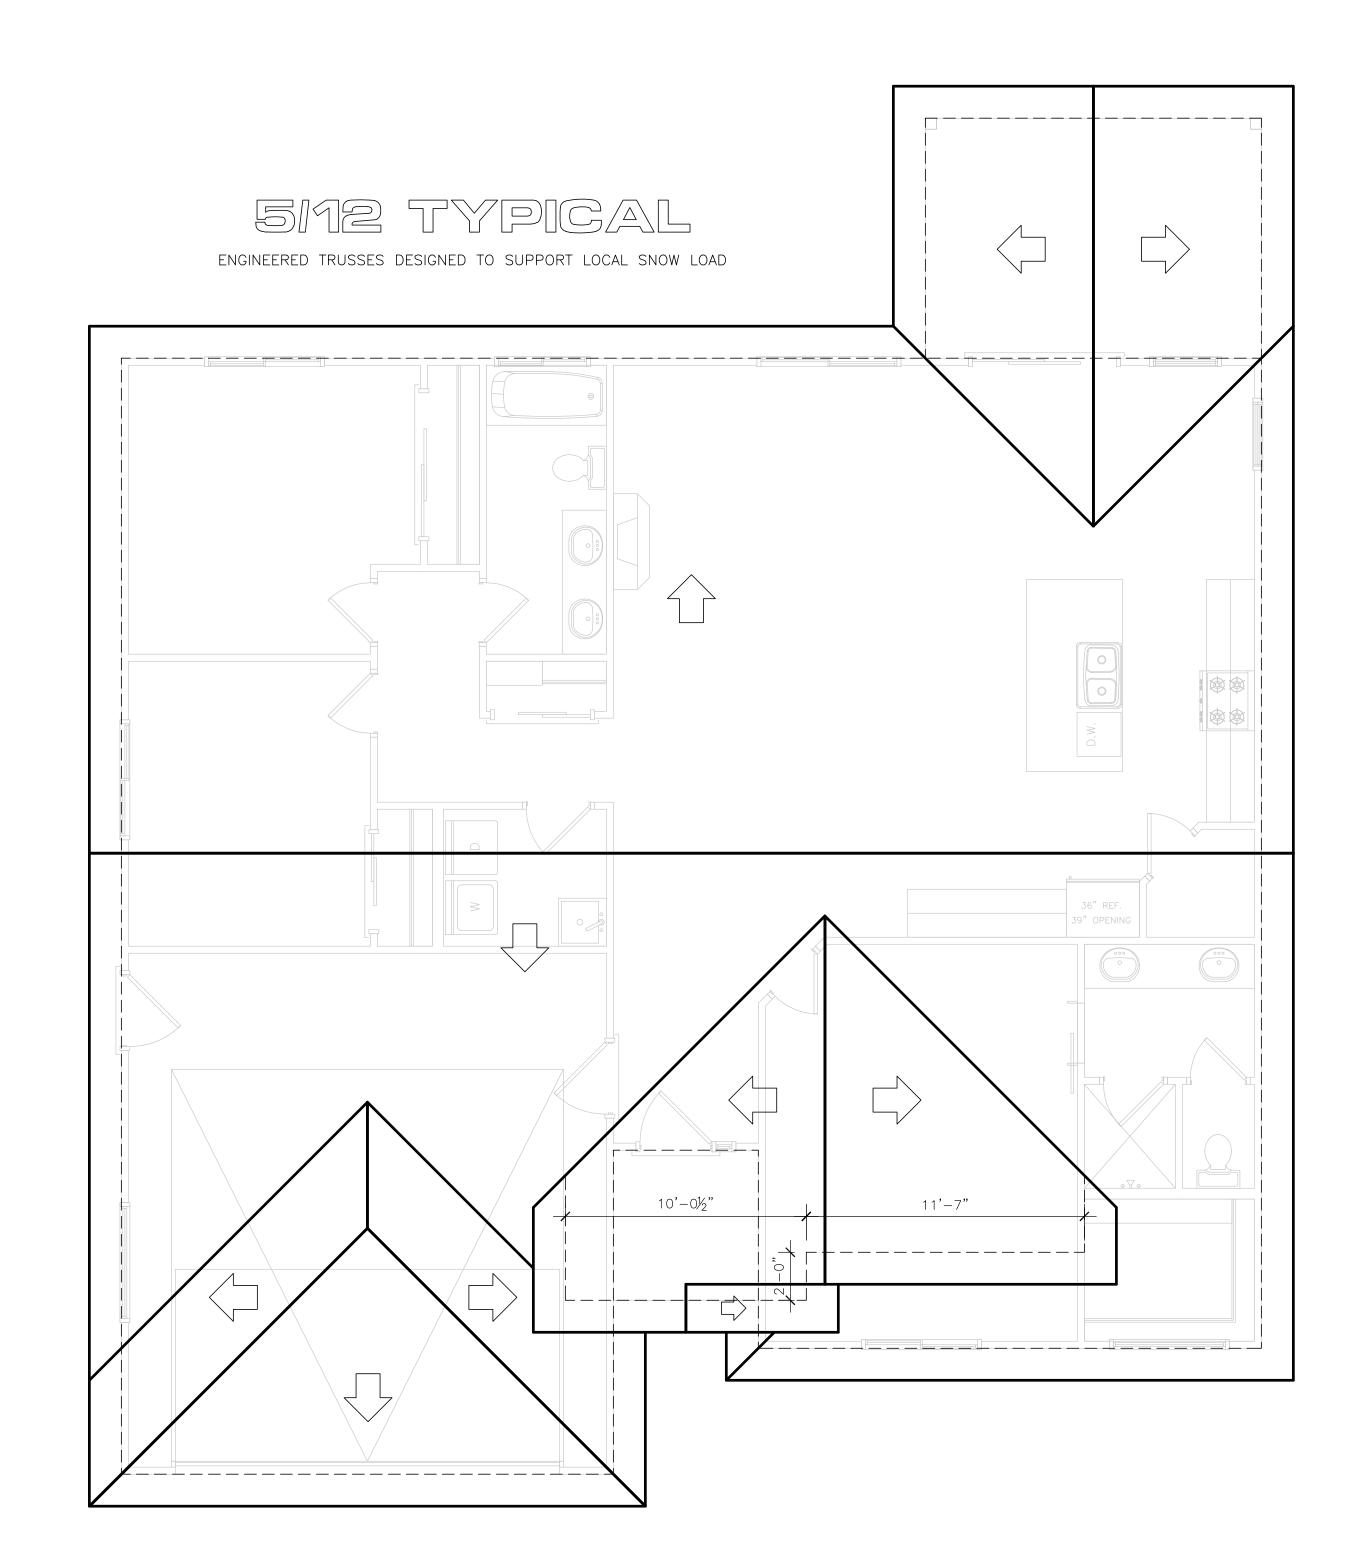

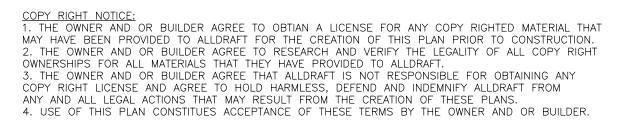

NOTES:

1. IT IS THE RESPONSIBILITY OF THE OWNER AND OR BUILDER TO VERIFY ALL DIMENSIONS AND DETAILS PRIOR TO CONSTRUCTION.

2. THESE PLANS ARE INTENDED FOR USE BY AN EXPERIENCED BUILDER.

3. AN INEXPERIENCED BUILDER MAY NEED TO CONSULT OTHER PROFESSIONALS SUCH AS AN ENGINEER AND OR OTHER CONSULTANTS.

4. USE OF THIS PLAN CONSTITUTES BUILDER AND OR OWNER ACCEPTANCE OF THESE TERMS.

5. ALL DIMENSIONS ARE TO FACE OF STUD UNLESS NOTED OTHERWISE.

6. 2X4 WALLS ARE DRAWN 3.5" AND 2X6 WALLS ARE DRAWN 5.5".

7. THIS PLANS HAS NOT BEEN ENGINEERED. SEE ENGINEERED PLAN BY OTHERS.


8. THIS PLAN IS COPYRIGHTED BY ALLDRAFT UNLESS NOTED OTHERWISE — COPYRIGHT © 2016 UNAUTHORIZED USE OF THESE PLANS IS PROHIBITED BY LAW — DMCA 1996


GRADE MUST SLOPE AWAY FROM HOUSE 6" OF FALL IN THE FIRST 10' OF DISTANCE PER LOCAL BUILDING CODE. NOTE:

BUILDER TO VERIFY ALL SETBACK AND EASEMENT ENCROACHMENTS PRIOR TO CONSTRUCTION

NOTE:

DIMENSION LINES ARE PULLED FROM EDGE OF BRICK LEDGE. IF NO BRICK LEDGE EXISTS, DIMENSIONS WILL BE FROM EDGE OF FOUNDATION.

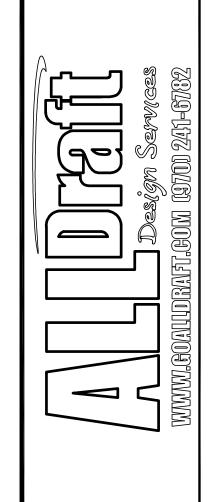

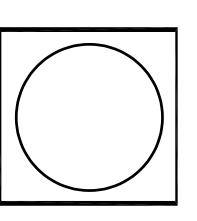



ALLDRAFT

CAD FILE

6-26-2020

1/8" = 1'-0'

SITE


MINIMUM OF 6 INCHES WITHIN THE FIRST 10 FEET.

DRAINAGE NOTE:

FINISHED GRADE TO SLOPE AWAY FROM STRUCTURE TO BE A

- 2. USE OF THIS PLAN CONSTITUTES BUILDER AND OR HOME OWNERS ACCEPTANCE OF THESE TERMS.
- 4. BUILDER AND OR OWNER TO VERIFY ALL SETBACKS AND EASEMENTS.
- 5. THIS PLAN HAS NOT BEEN ENGINEERED BY AUTODRAFT. SEE SEPARATE DRAWINGS BY OTHERS FOR ENGINEERING DATA.

# ARABESQUE DRIVE

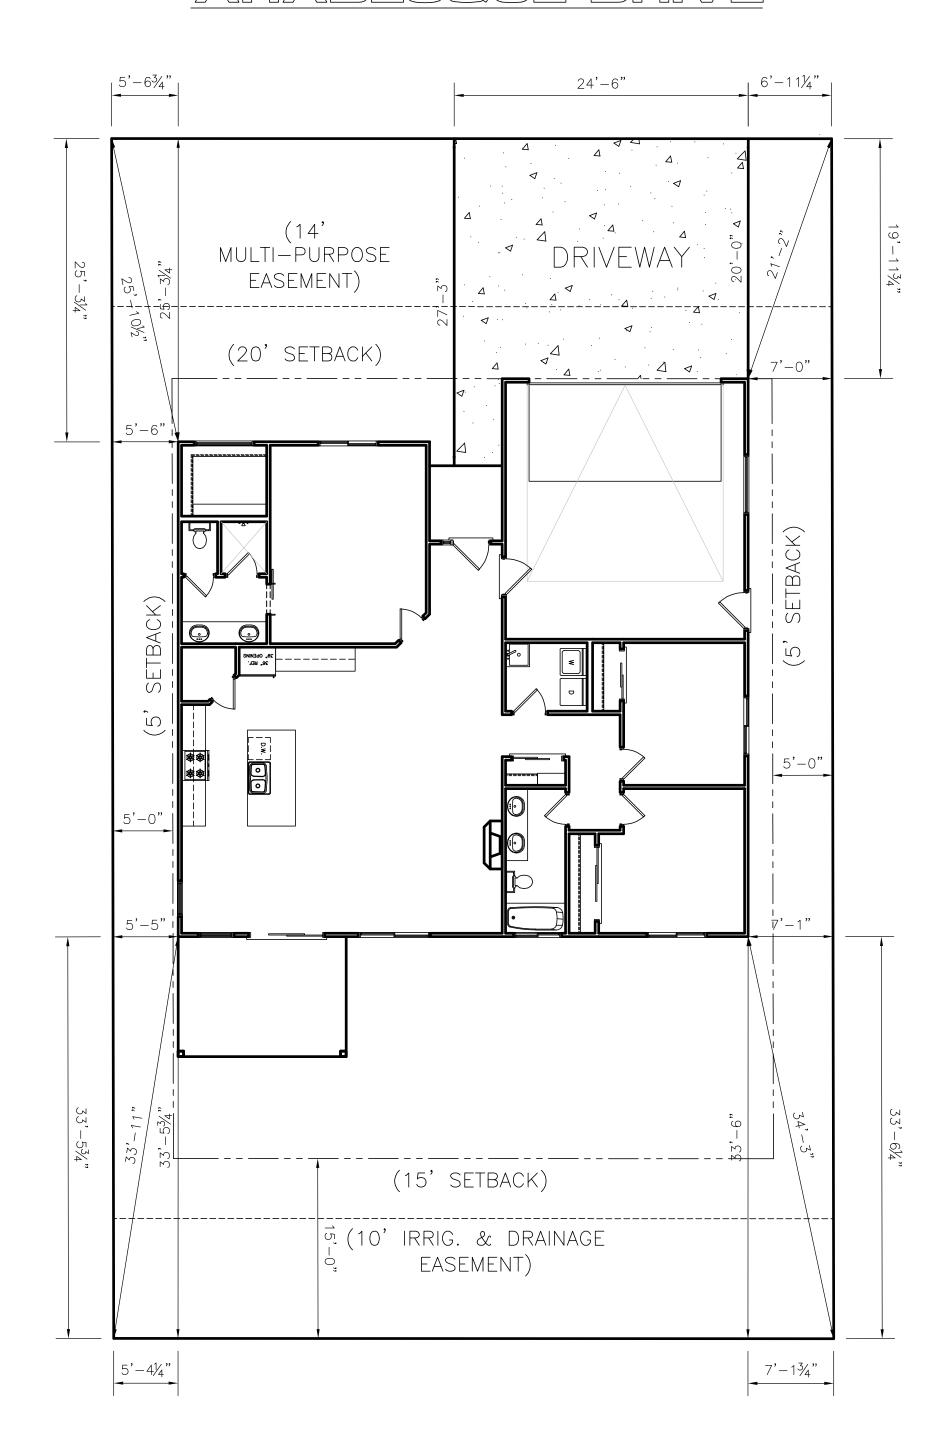

SCALE: 1/87 = 17-07

COPY RIGHT NOTICE:

1. THE OWNER AND OR BUILDER AGREE TO OBTIAN A LICENSE FOR ANY COPY RIGHTED MATERIAL THAT MAY HAVE BEEN PROVIDED TO ALLDRAFT FOR THE CREATION OF THIS PLAN PRIOR TO CONSTRUCTION.

2. THE OWNER AND OR BUILDER AGREE TO RESEARCH AND VERIFY THE LEGALITY OF ALL COPY RIGHT OWNERSHIPS FOR ALL MATERIALS THAT THEY HAVE PROVIDED TO ALLDRAFT.

3. THE OWNER AND OR BUILDER AGREE THAT ALLDRAFT IS NOT RESPONSIBLE FOR OBTAINING ANY COPY RIGHT LICENSE AND AGREE TO HOLD HARMLESS, DEFEND AND INDEMNIFY ALLDRAFT FROM ANY AND ALL LEGAL ACTIONS THAT MAY RESULT FROM THE CREATION OF THESE PLANS.

4. USE OF THIS PLAN CONSTITUES ACCEPTANCE OF THESE TERMS BY THE OWNER AND OR BUILDER.

1. IT IS THE RESPONSIBILITY OF THE BUILDER OR OWNER TO VERIFY ALL DETAILS AND DIMENSIONS PRIOR TO CONSTRUCTION.

3. ALL DIMENSIONS ARE TO EDGE OF FOUNDATION UNLESS OTHER WISE NOTED.

NOTES:

1. IT IS THE RESPONSIBILITY OF THE OWNER AND OR BUILDER TO
VERIFY ALL DIMENSIONS AND DETAILS PRIOR TO CONSTRUCTION.

2. THESE PLANS ARE INTENDED FOR USE BY AN EXPERIENCED BUILDER.

3. AN INEXPERIENCED BUILDER MAY NEED TO CONSULT OTHER
PROFESSIONALS SUCH AS AN ENGINEER AND OR OTHER CONSULTANTS.

4. USE OF THIS PLAN CONSTITUTES BUILDER AND OR OWNER ACCEPTANCE OF THESE TERMS. 5. ALL DIMENSIONS ARE TO FACE OF STUD UNLESS NOTED OTHERWISE. 6. 2X4 WALLS ARE DRAWN 3.5" AND 2X6 WALLS ARE DRAWN 5.5". 7. THIS PLANS HAS NOT BEEN ENGINEERED. SEE ENGINEERED PLAN BY OTHERS. 8. THIS PLAN IS COPYRIGHTED BY ALLDRAFT UNLESS NOTED OTHERWISE - COPYRIGHT @ 2016 UNAUTHORIZED USE OF THESE PLANS IS PROHIBITED BY LAW - DMCA 1996

<u>FLOORPLAN PLAN</u> THIS FOUNDATION DESIGN WAS BASED UPON A FLOOR PLAN GENERATED BY: ALL DRAFT DATED: 06-26-2020

THE BUILDER SHALL VERIFY THAT A FLOOR FRAMING PLAN HAS BEEN DESIGNED TO BE COMPATIBLE WITH THIS FOUNDATION PLAN.

TRUSS PLAN THIS FOUNDATION PLAN IS BASED ON A TRUSS PLAN PROVIDED BY:

N/A - DATED: X/X/X

THE BUILDER SHALL VERIFY THAT A TRUSS PLAN HAS BEEN DESIGNED TO BE COMPATIBLE WITH THIS FOUNDATION PLAN.

CONTRACTOR TO VERIFY ALL DIMENSIONS AND DETAILS PRIOR TO CONSTRUCTION. CONTRACTOR SHALL NOTIFY ENGINEER OF ANY DISCREPANCIES PRIOR TO CONSTRUCTION.

ALL WORK WILL CONFORM TO IRC 2018 CODE OR CURRENT ADOPTED LOCAL CODE.

# <u>CONCRETE</u>

28 DAY COMPRESSIVE STRENGTH OF 3000 PSI. MIN. TYPE II CEMENT

REINFORCING STEEL NEW DEFORMED BILLET STEEL PER ASTM A-615, GRADE 60. LAP ALL #5 REBAR 25" LAP ALL #4 REBAR 20" LAP ALL #3 REBAR 15"

FLOAT & STEEL TROWEL LIGHT BROOM FINISH - EXTERIOR

COMPLY W/ ACI-301-72.11.1 SAW CUTTING FILL CUTS W/ EPOXY JOINT COMPOUND PROVIDE TOOLED OR SAW CUTS @ 12' O.C. MAX. TO MINIMIZE CRACKING.


# <u>CURING</u>


COMPLY W/ ACI-301-727 DAYS @ OPT. MOISTURE CONTENT


SLOPE EXTERIOR CONCRETE AWAY FROM STRUCTURE A MIN. OF 1/8": 1'-0"

# SOIL PREPARATION

BUILDER/OWNER IS RESPONSIBLE FOR PROPER SOILS PREPARATION AND SHALL VERIFY THAT SITE PREPARATION IS SUITABLE FOR CONSTRUCTION.

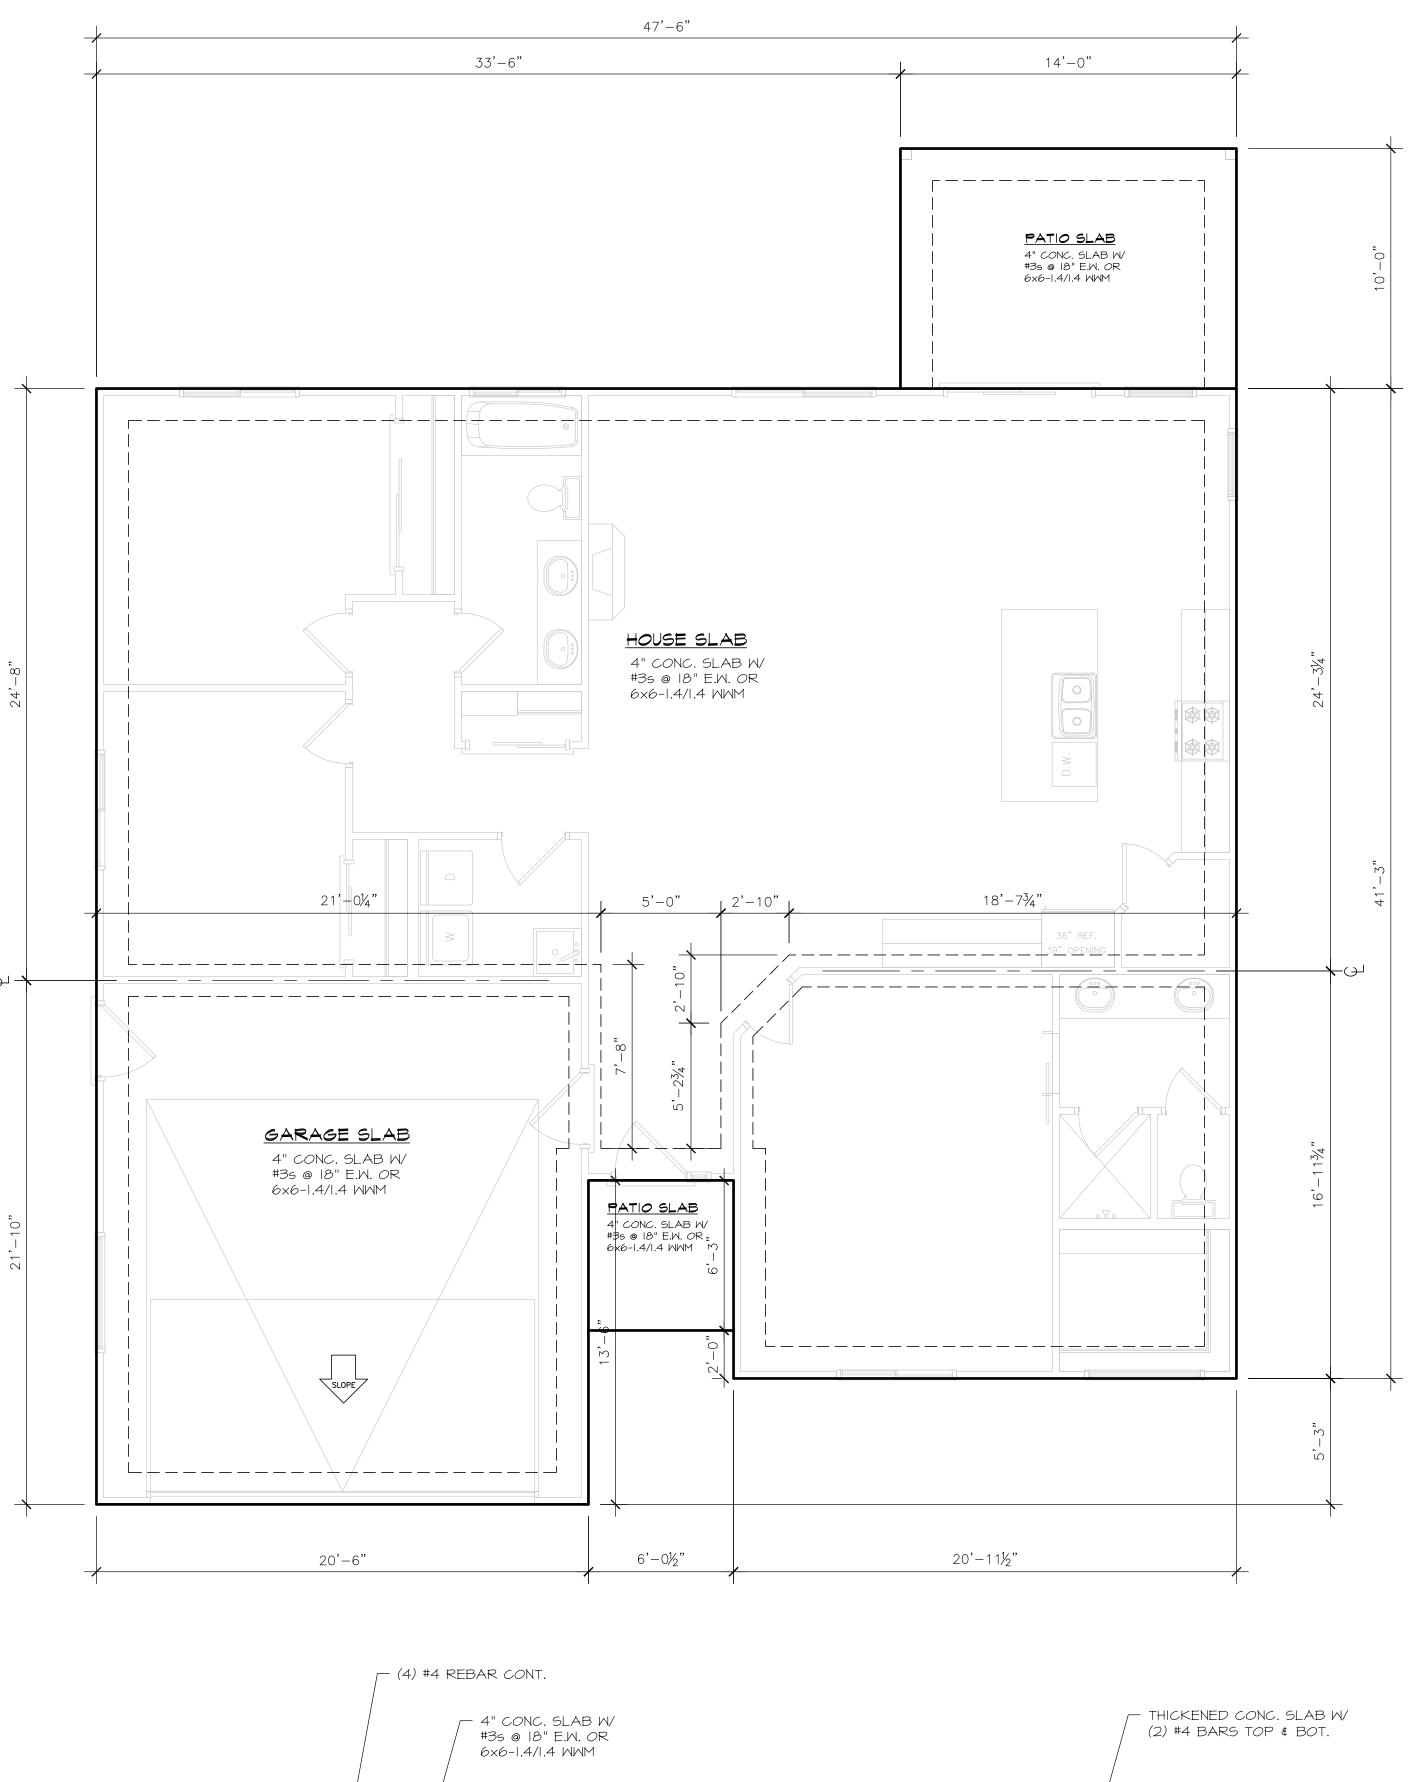

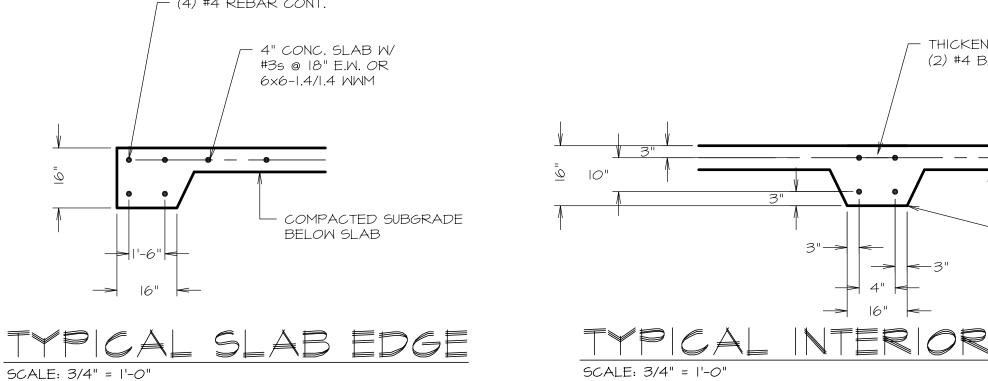

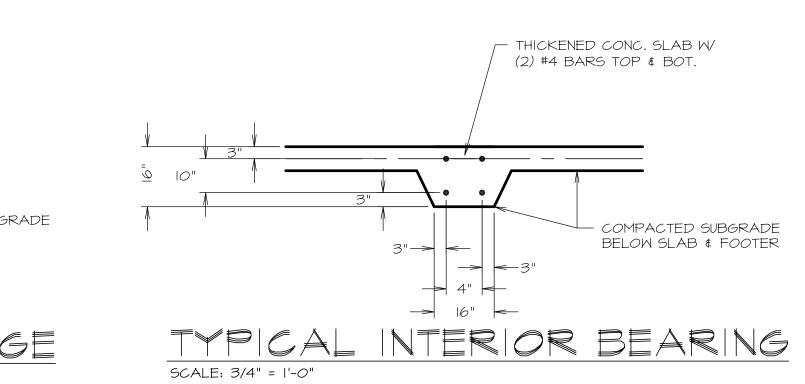

COPY RIGHT NOTICE:

1. THE OWNER AND OR BUILDER AGREE TO OBTIAN A LICENSE FOR ANY COPY RIGHTED MATERIAL THAT MAY HAVE BEEN PROVIDED TO ALLDRAFT FOR THE CREATION OF THIS PLAN PRIOR TO CONSTRUCTION.

2. THE OWNER AND OR BUILDER AGREE TO RESEARCH AND VERIFY THE LEGALITY OF ALL COPY RIGHT OWNERSHIPS FOR ALL MATERIALS THAT THEY HAVE PROVIDED TO ALLDRAFT.

3. THE OWNER AND OR BUILDER AGREE THAT ALLDRAFT IS NOT RESPONSIBLE FOR OBTAINING ANY COPY RIGHT LICENSE AND AGREE TO HOLD HARMLESS, DEFEND AND INDEMNIFY ALLDRAFT FROM ANY AND ALL LEGAL ACTIONS THAT MAY RESULT FROM THE CREATION OF THESE PLANS.

4. USE OF THIS PLAN CONSTITUES ACCEPTANCE OF THESE TERMS BY THE OWNER AND OR BUILDER.

DRAWN BY ALLDRAFT CAD FILE 7-7-2020 1/4" = 1'-0"**S1**