FINAL PLANS FOR CONSTRUCTION DATE: 08-14-2020

NOTES:


1. IT IS THE RESPONSIBILITY OF THE OWNER AND OR BUILDER TO VERIFY ALL DIMENSIONS AND DETAILS PRIOR TO CONSTRUCTION.


2. THESE PLANS ARE INTENDED FOR USE BY AN EXPERIENCED BUILDER.


3. AN INEXPERIENCED BUILDER MAY NEED TO CONSULT OTHER PROFESSIONALS SUCH AS AN ENGINEER AND OR OTHER CONSULTANTS.

4. USE OF THIS PLAN CONSTITUTES BUILDER AND OR OWNER ACCEPTANCE OF THESE TERMS.

5. ALL DIMENSIONS ARE TO FACE OF STUD UNLESS NOTED OTHERWISE. 6. 2X4 WALLS ARE DRAWN 3.5" AND 2X6 WALLS ARE DRAWN 5.5". 6. 2X4 WALLS ARE DRAWN 3.5 AND 2X6 WALLS ARE DRAWN 5.5.
7. THIS PLANS HAS NOT BEEN ENGINEERED. SEE ENGINEERED PLAN BY OTHERS.
8. THIS PLAN IS COPYRIGHTED BY ALLDRAFT UNLESS NOTED OTHERWISE — COPYRIGHT©2016
UNAUTHORIZED USE OF THESE PLANS IS PROHIBITED BY LAW — DMCA 1996

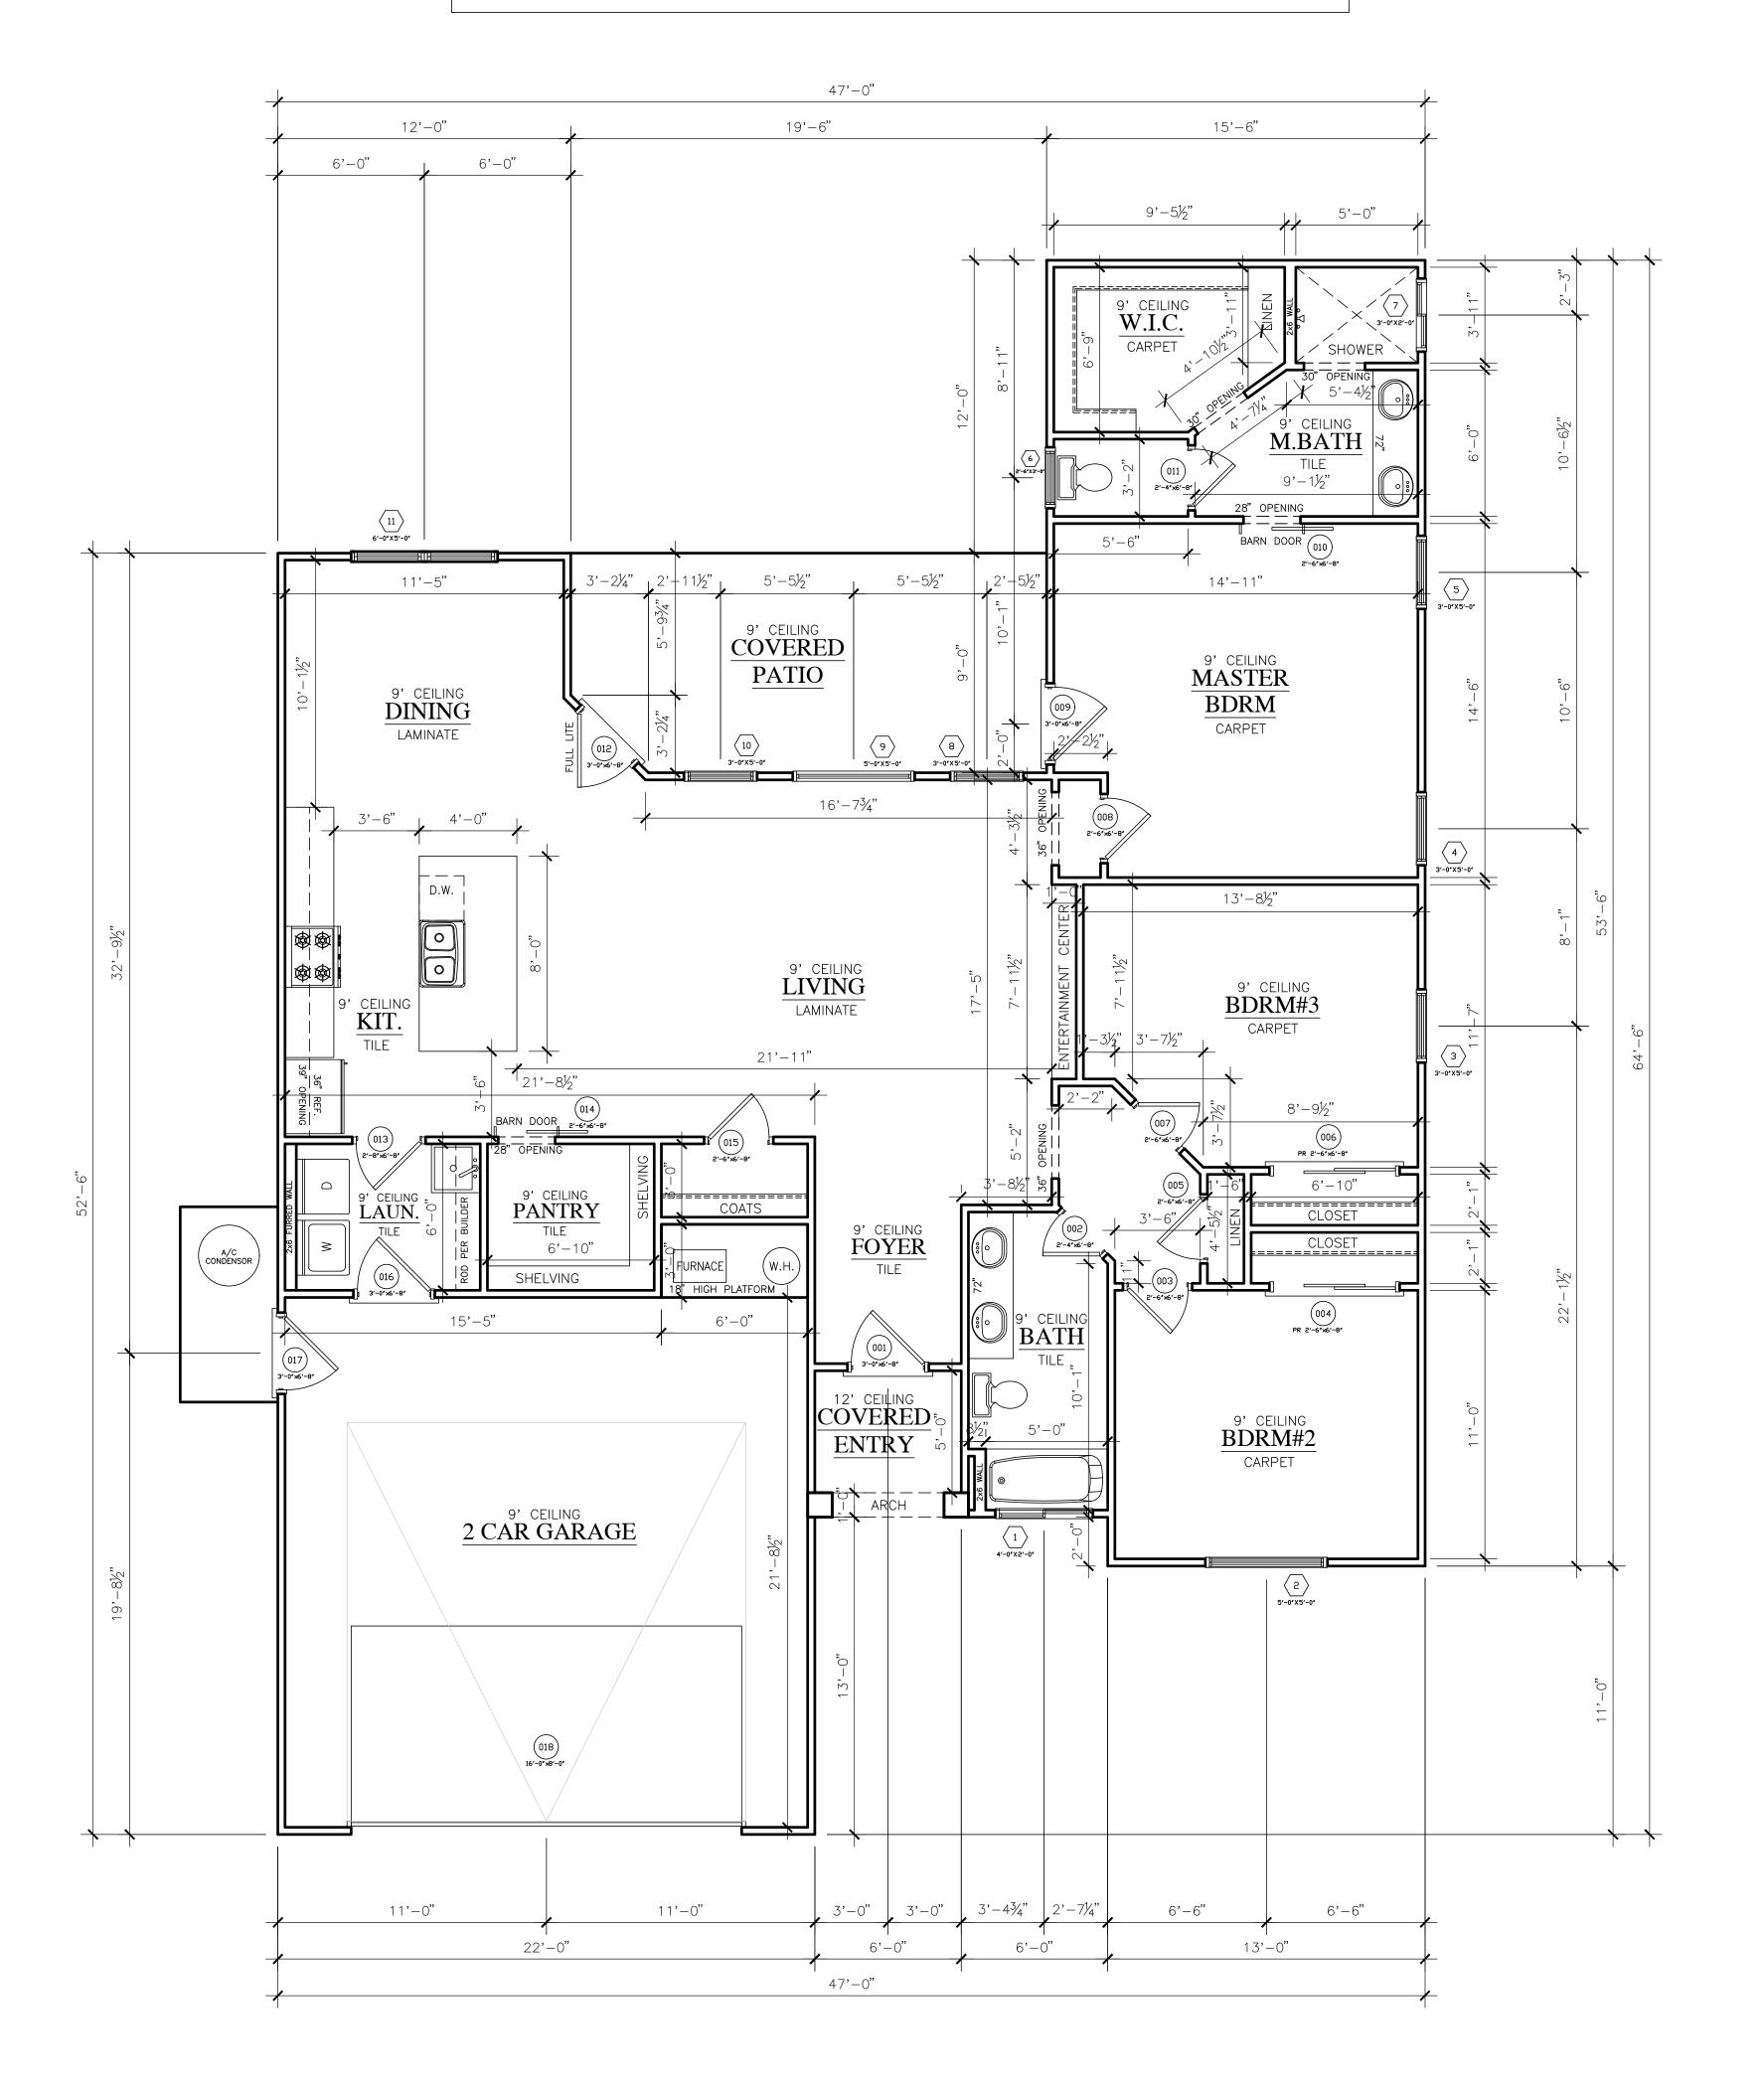

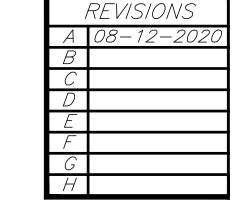

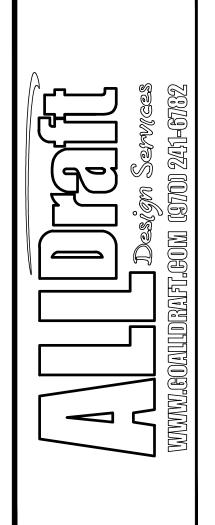

DOOR

3'-0"

2'-6"

2'-6"

6'-8"

6'-8"

6'-8"

6'-8"

6'-8"

MARK


001

003

005

006

011

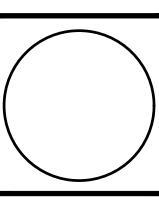


	SIZE		
MARK	WIDTH	HEIGHT	Style
001	4'-0"	2'-0"	Glider
002	5'-0"	5'-0"	Double Hung
003	3'-0"	5'-0"	Double Hung
004	3'-0"	5'-0"	Double Hung
005	3'-0"	5'-0"	Double Hung
006	2'-6"	3'-0"	Double Hung
007	3'-0"	2'-0"	Glider
008	3'-0"	5'-0"	Double Hung
009	5'-0"	5'-0"	Picture
010	3'-0"	5'-0"	Double Hung
011	6'-0"	5'-0"	DBL.SH

SQUARE	FOOTAGE	
TABLE		
SPACE	AREA	
GARAGE SF	501.13 SF	

1646.94 SF

LIVING SPACE

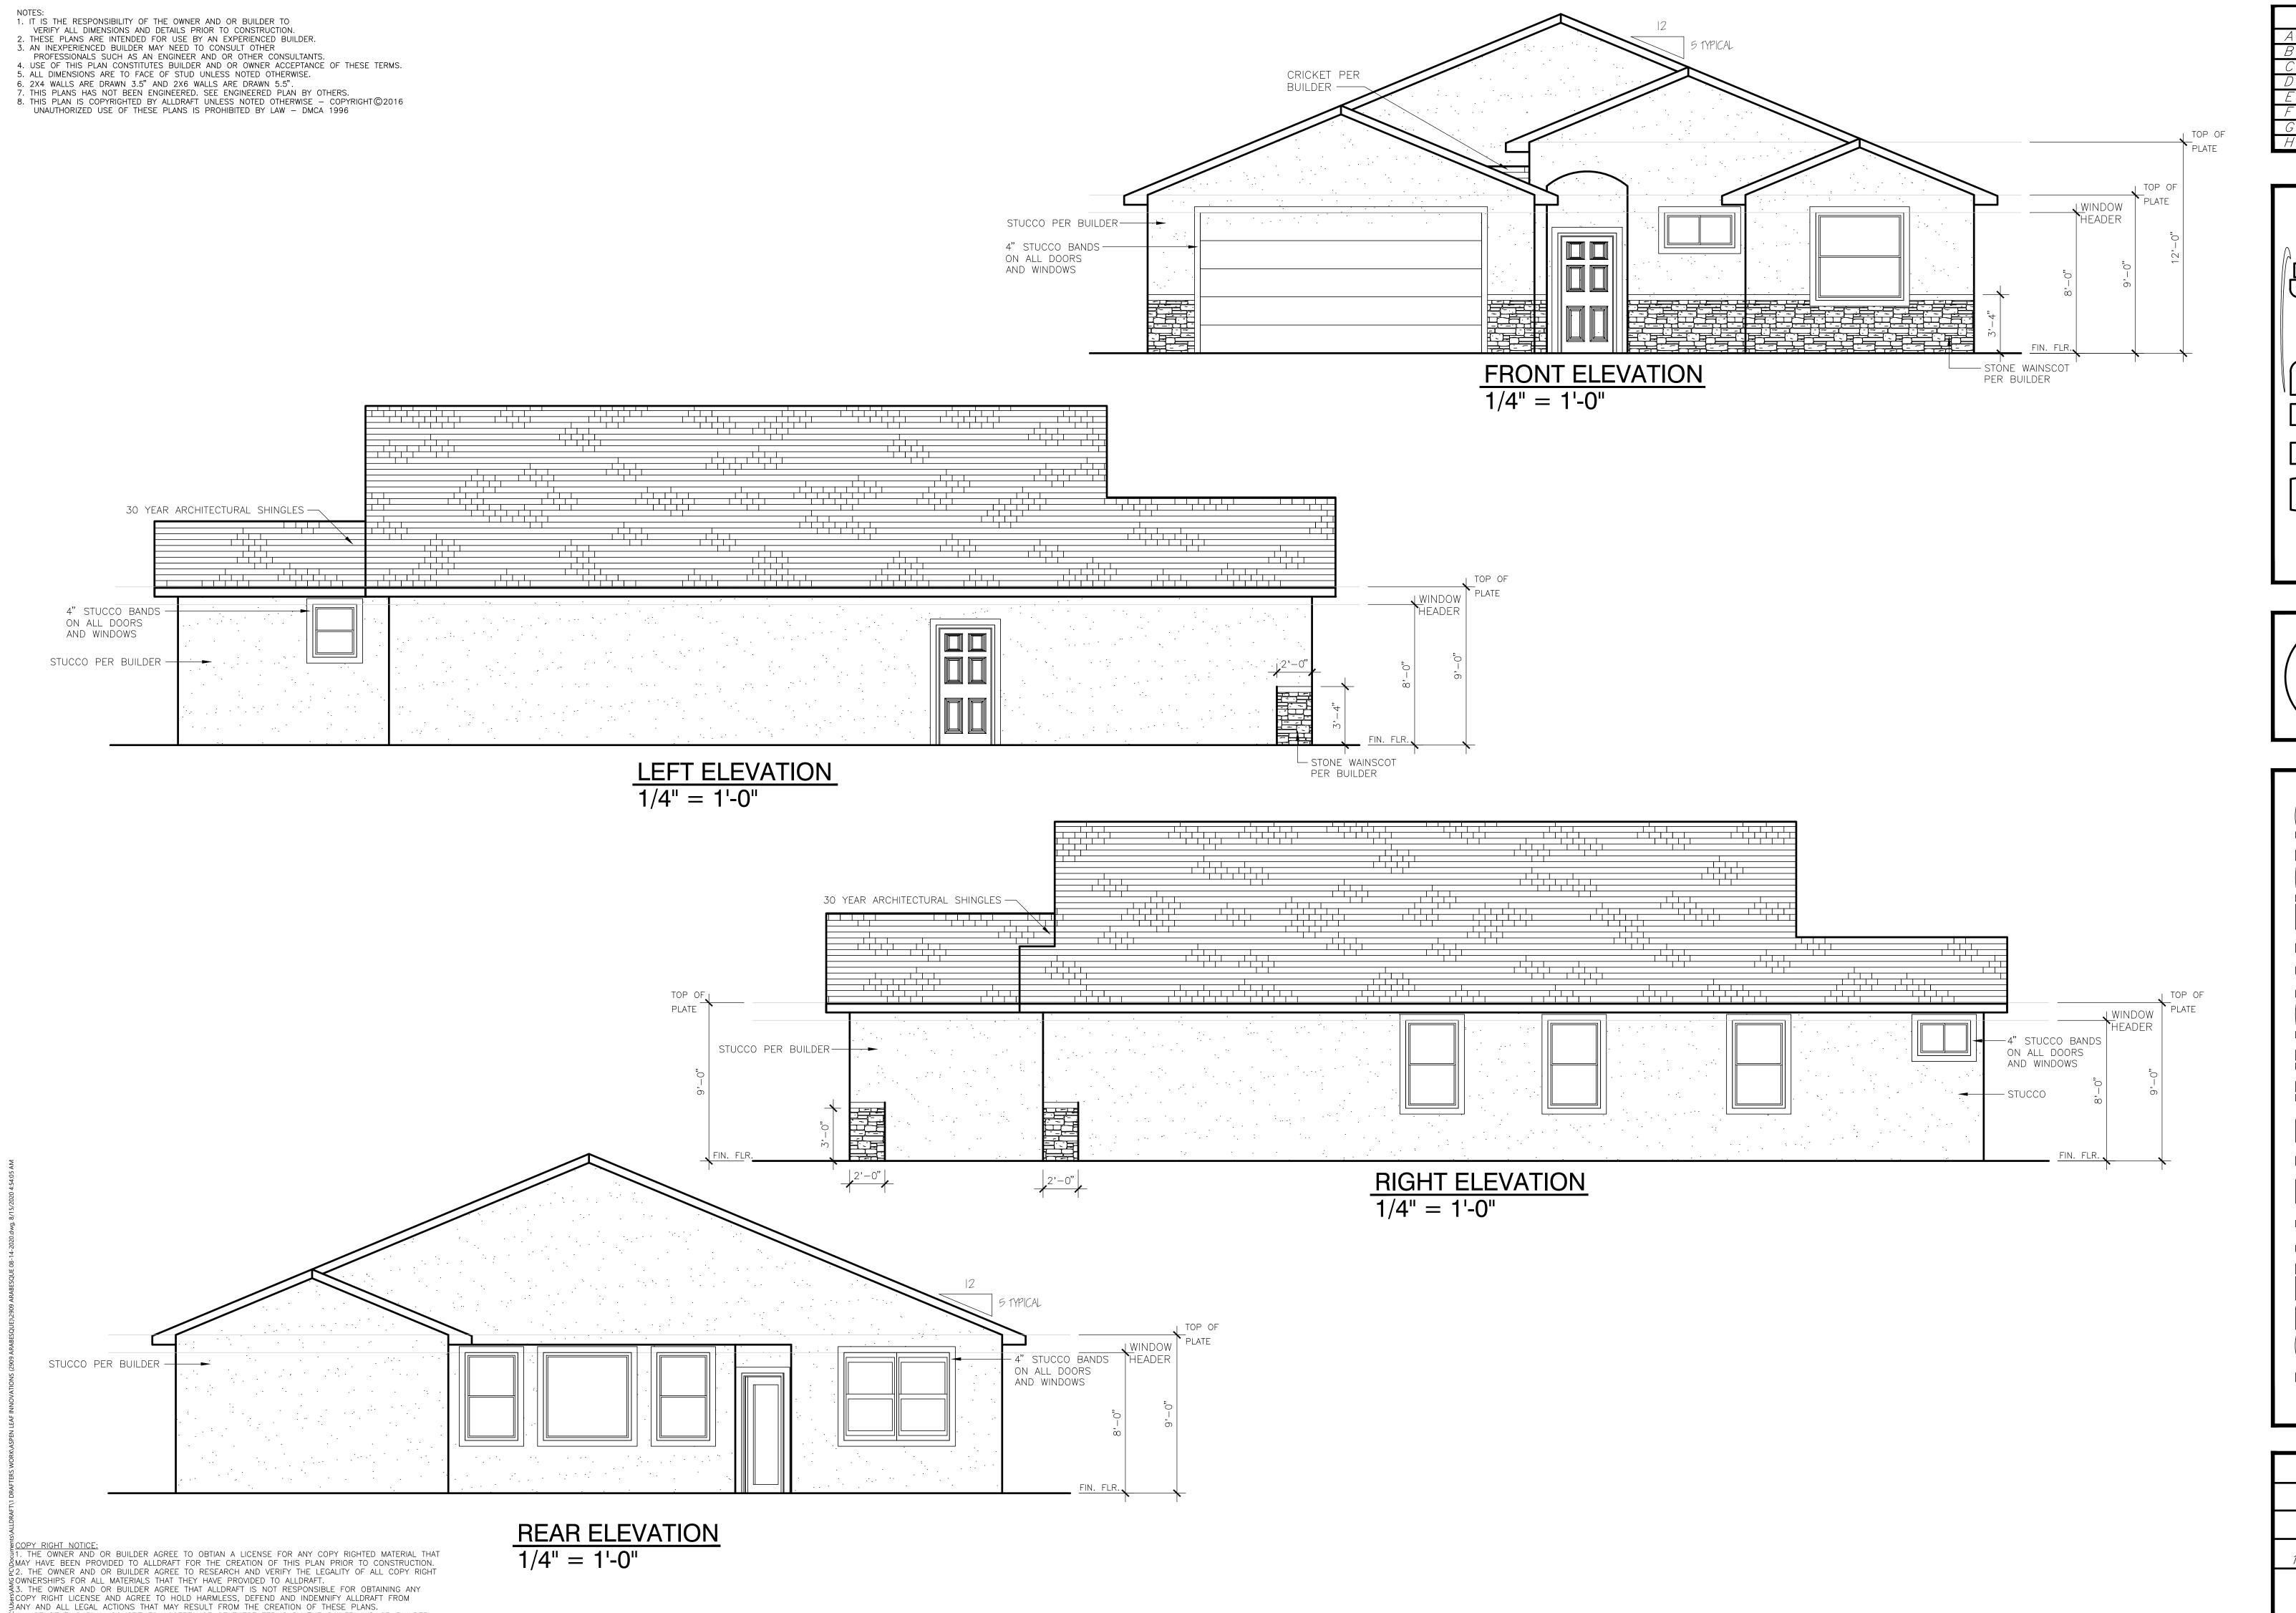


 $^{\circ}$ 4. USE OF THIS PLAN CONSTITUES ACCEPTANCE OF THESE TERMS BY THE OWNER AND OR BUILDER.


REVISIONS

A 08-12-2020

B C

D |
E |
F |
G |
H

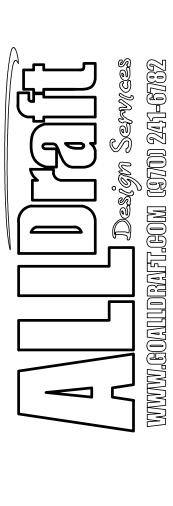

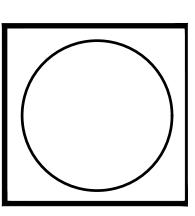

ASPEN LEAF INNOVATIONS
2909 ARABESQUE DRIVE
LOT 5 BLK 1 ARABESQUE SUB,

DRAWN BY

ALLDRAFT

FILE NAME

CAD FILE


DATE

08-14-2020

SCALE

1/4" = 1'-0"

SHEET

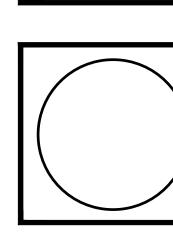

R=38 INSULATION MIN.

W/ CLIPS FASCIA

W/ VENTS PER IRC 2018

SOFFIT

- 1/2" GYPSUM WALL BOARD

— WALL SHEATHING PER BUILDER'S SPECS.

— 1/2" ANCHOR BOLTS @ 48" O.C.

- MONOLITHIC SLAB FOUNDATION
PER LOCAL CODE OR ENGINEERED

--- VINYL WINDOWS

R=13 INSULATION

BY OTHERS

—— 2X4 STUDS @ 16" O.C.

30 YEAR ARCHITECTURAL SHINGLES & 30# FELT

ENGINEERED TRUSSES @ 2' O.C. SCISSOR TRUSSES @ VAULTED AREAS

7/16" OSB ROOF SHEATHING

ALLDRAFT FILE NAME CAD FILE 08-14-2020 1/4" = 1'-0"

**A3** 

### DOOR AND WINDOW HEADER SCHEDULE

HEADER SIZE OPENING WIDTH (2) 2X8 HEM-FIR (2) 2X8 HEM-FIR (2) 2X12 HEM-FIR (3) 2X12 HEM-FIR (3) 2X12 HEM-FIR (2)  $1 - \frac{3}{4} \times 11 - \frac{7}{8}$  ML (2)  $1 - \frac{3}{4} \times 11 - \frac{7}{8}$  ML (2)  $1 - \frac{3}{4} \times 11 - \frac{7}{8}$  ML

HEADERS BELOW A GIRDER TRUSS OR BELOW ANY ADDITIONAL POINT LOAD SHOULD BE REVIEWED BY AN ENGINEER.

BASEMENTS IN DWELLING UNITS AND EVERY SLEEPING ROOM BELOW THE FOURTH STORY MUST HAVE ONE OPERABLE

OR EXTERIOR DOOR APPROVED FOR ESCAPE OR RESCUE.

ESCAPE OR RESCUE WINDOWS SHALL HAVE A MINIMUM NET CLEAR OPENING OF 5.7 SQUARE FEET. MINIMUM NET

OPENING HEIGHT IS 24 INCHES. THE MINIMUM NET CLEAR OPENING WIDTH IS 20". THE MAXIMUM SILL HEIGHT IS 44 INCHES FROM THE FLOOR.

## VENTILATION AND LIGHTING NOTES:

ALL ROOMS MUST MEET MINIMUM VENTILATION AND LIGHTING REQUIREMENTS.

VENTILATION - .04% PER SQUARE FOOT LIGHTING - .08% PER SQUARE FOOT

EGRESS STANDARDS ALSO APPLY


# EXTERIOR WALL PLUMBING NOTES:


NO P TRAPS, WATER OR HEAT LINES ALLOWED IN OUTSIDE WALLS, WALLS COMMON TO GARAGE OR CEILINGS UNLESS DEEP ENOUGH OR

ATTIC SPACE IS CONSIDERED TO BE AN OUTSIDE WALL.

IF HEATED.

NEED 12" GYP-BOARD ON GARAGE SIDE OF SEPARATION BETWEEN HOUSE AND GARAGE. EQUALLY PROTECT WALLS AND MEMBERS SUPPORTING SEPARATION. NEED 5/8" TYPE "X" GYP-BOARD ON CELINGS OF GARAGES WITH HABITABLE SPACE ABOVE. DOORS IN SEPARATION WALLS MUST BE  $1-\frac{3}{8}$ " SOLID WOOD OR STEEL.

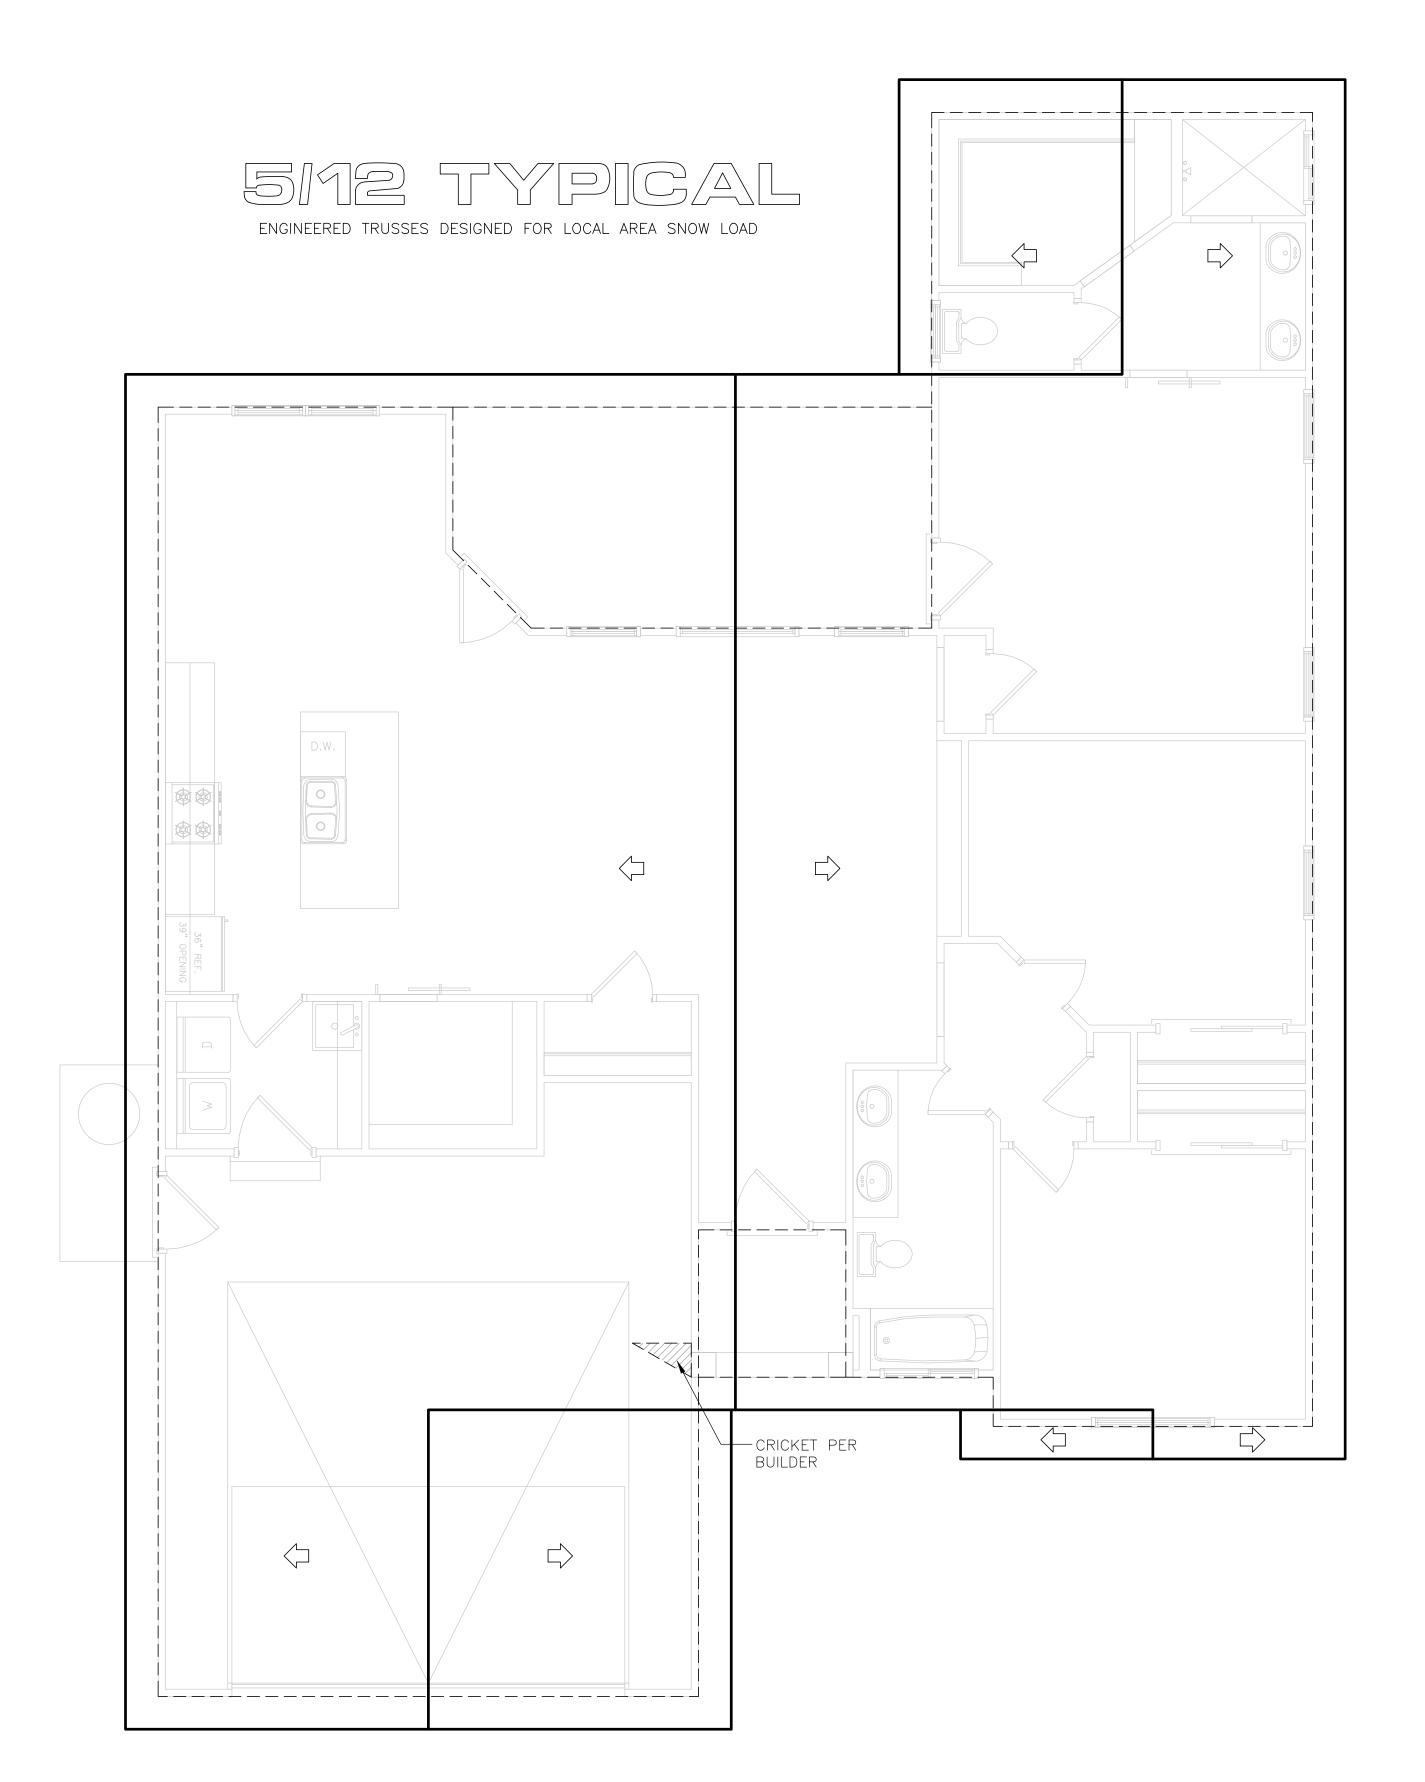

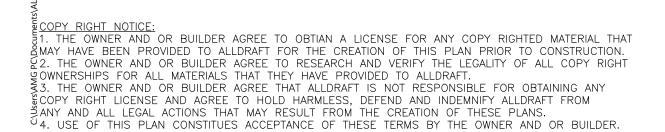

NOTES:

1. IT IS THE RESPONSIBILITY OF THE OWNER AND OR BUILDER TO VERIFY ALL DIMENSIONS AND DETAILS PRIOR TO CONSTRUCTION.

2. THESE PLANS ARE INTENDED FOR USE BY AN EXPERIENCED BUILDER.

3. AN INEXPERIENCED BUILDER MAY NEED TO CONSULT OTHER PROFESSIONALS SUCH AS AN ENGINEER AND OR OTHER CONSULTANTS.

4. USE OF THIS PLAN CONSTITUTES BUILDER AND OR OWNER ACCEPTANCE OF THESE TERMS.


5. ALL DIMENSIONS ARE TO FACE OF STUD UNLESS NOTED OTHERWISE.

6. 2X4 WALLS ARE DRAWN 3.5" AND 2X6 WALLS ARE DRAWN 5.5".

7. THIS PLANS HAS NOT BEEN ENGINEERED SEE ENGINEERED PLAN BY OTHERS

7. THIS PLANS HAS NOT BEEN ENGINEERED. SEE ENGINEERED PLAN BY OTHERS.

8. THIS PLAN IS COPYRIGHTED BY ALLDRAFT UNLESS NOTED OTHERWISE — COPYRIGHT©2016
UNAUTHORIZED USE OF THESE PLANS IS PROHIBITED BY LAW — DMCA 1996

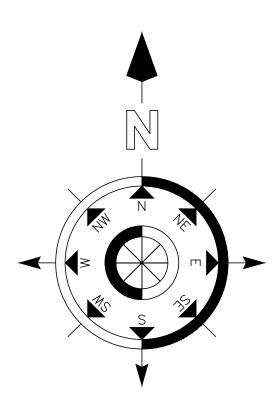



NOTE


GRADE MUST SLOPE AWAY FROM HOUSE 6" OF FALL IN THE FIRST 10' OF DISTANCE PER LOCAL BUILDING CODE. NOTE:

BUILDER TO VERIFY ALL SETBACK AND EASEMENT ENCROACHMENTS PRIOR TO CONSTRUCTION

DIMENSION LINES ARE PULLED FROM EDGE OF BRICK LEDGE. IF NO BRICK LEDGE EXISTS, DIMENSIONS WILL BE FROM EDGE OF FOUNDATION.

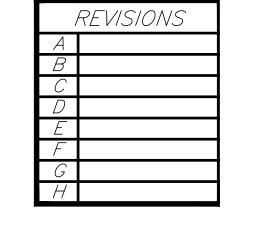

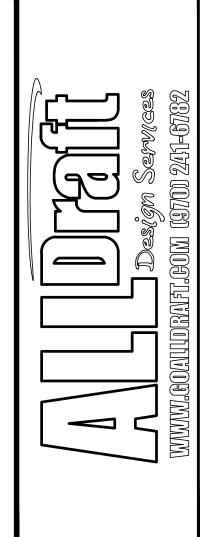

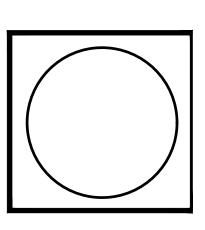

ALLDRAFT

CAD FILE

08-14-2020

1/8" = 1'-0"

SITE


FILE NAME

FINISHED GRADE TO SLOPE AWAY FROM STRUCTURE TO BE A MINIMUM OF 6 INCHES WITHIN THE FIRST 10 FEET.

DRAINAGE NOTE:

- 1. IT IS THE RESPONSIBILITY OF THE BUILDER OR OWNER TO VERIFY ALL DETAILS
- AND DIMENSIONS PRIOR TO CONSTRUCTION.
- 2. USE OF THIS PLAN CONSTITUTES BUILDER AND OR HOME OWNERS ACCEPTANCE OF THESE TERMS.
- 3. ALL DIMENSIONS ARE TO EDGE OF FOUNDATION UNLESS OTHER WISE NOTED. 4. BUILDER AND OR OWNER TO VERIFY ALL SETBACKS AND EASEMENTS.
- 5. THIS PLAN HAS NOT BEEN ENGINEERED BY AUTODRAFT. SEE SEPARATE DRAWINGS BY OTHERS FOR ENGINEERING DATA.

# ARABESQUE DRIVE

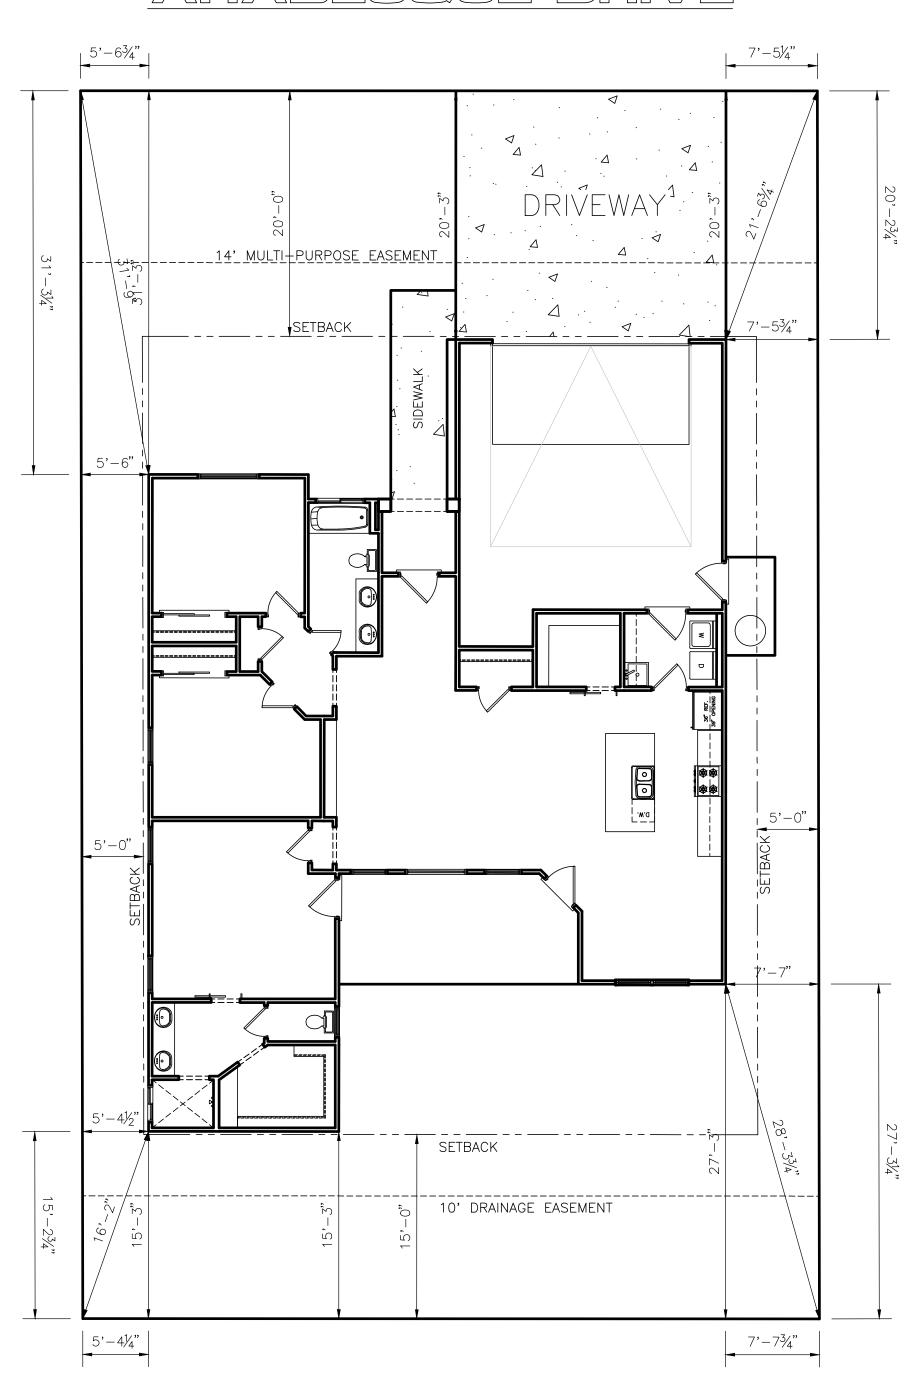

SCALE: 1/84 = 11-04

COPY RIGHT NOTICE:

51. THE OWNER AND OR BUILDER AGREE TO OBTIAN A LICENSE FOR ANY COPY RIGHTED MATERIAL THAT AMAY HAVE BEEN PROVIDED TO ALLDRAFT FOR THE CREATION OF THIS PLAN PRIOR TO CONSTRUCTION.

22. THE OWNER AND OR BUILDER AGREE TO RESEARCH AND VERIFY THE LEGALITY OF ALL COPY RIGHT OWNERSHIPS FOR ALL MATERIALS THAT THEY HAVE PROVIDED TO ALLDRAFT.

3. THE OWNER AND OR BUILDER AGREE THAT ALLDRAFT IS NOT RESPONSIBLE FOR OBTAINING ANY COPY RIGHT LICENSE AND AGREE TO HOLD HARMLESS, DEFEND AND INDEMNIFY ALLDRAFT FROM ANY AND ALL LEGAL ACTIONS THAT MAY RESULT FROM THE CREATION OF THESE PLANS. <sup>1</sup>4. USE OF THIS PLAN CONSTITUES ACCEPTANCE OF THESE TERMS BY THE OWNER AND OR BUILDER.

FLOORPLAN

THIS FOUNDATION DESIGN WAS BASED UPON A FLOOR PLAN GENERATED BY:
ALLDRAFT
DATED: 08-14-2020

TRUSS PLAN

THIS FOUNDATION PLAN IS BASED ON A TRUSS PLAN PROVIDED BY:

COMPANY NAME - DATED: 00/00/2020 JOB #: N/A

THE BUILDER SHALL VERIFY THAT A TRUSS
PLAN HAS BEEN DESIGNED TO BE COMPATIBLE WITH THIS
FOUNDATION PLAN.

GENERAI

CONTRACTOR TO VERIFY ALL DIMENSIONS AND DETAILS PRIOR TO CONSTRUCTION. CONTRACTOR SHALL NOTIFY ENGINEER OF ANY DESCREPANCIES PRIOR TO CONSTRUCTION.

ALL WORK WILL CONFORM TO IRC 2018 CODE OR CURRENT ADOPTED LOCAL CODE.

<u>CONCRETE</u>

28 DAY COMPRESSIVE STRENGTH
OF 3000 PSI. MIN. TYPE II CEMENT

REINFORCING STEEL

NEW DEFORMED BILLET STEEL PER ASTM A-615, GRADE 60. LAP ALL #5 REBAR 25" LAP ALL #4 REBAR 20" LAP ALL #3 REBAR 15"

<u>FINISHING</u> FLOAT & STEEL TROWEL LIGHT BROOM FINISH — EXTERIOR

<u>JOINTING</u>

COMPLY W/ ACI-301-72.11.1 SAW CUTTING FILL CUTS W/ EPOXY JOINT COMPOUND PROVIDE TOOLED OR SAW CUTS @ 12' O.C. MAX. TO MINIMIZE CRACKING.


<u>CURING</u>


COMPLY W/ ACI-301-72 7 DAYS @ OPT. MOISTURE CONTENT

SLOPE EXTERIOR CONCRETE AWAY FROM STRUCTURE A MIN. OF 1/8": 1'-0"


SOIL PREPARATION

BUILDER/OWNER IS RESPONSIBLE FOR PROPER SOILS PREPARATION AND SHALL VERIFY THAT SITE PREPARATION IS SUITABLE FOR CONSTRUCTION.

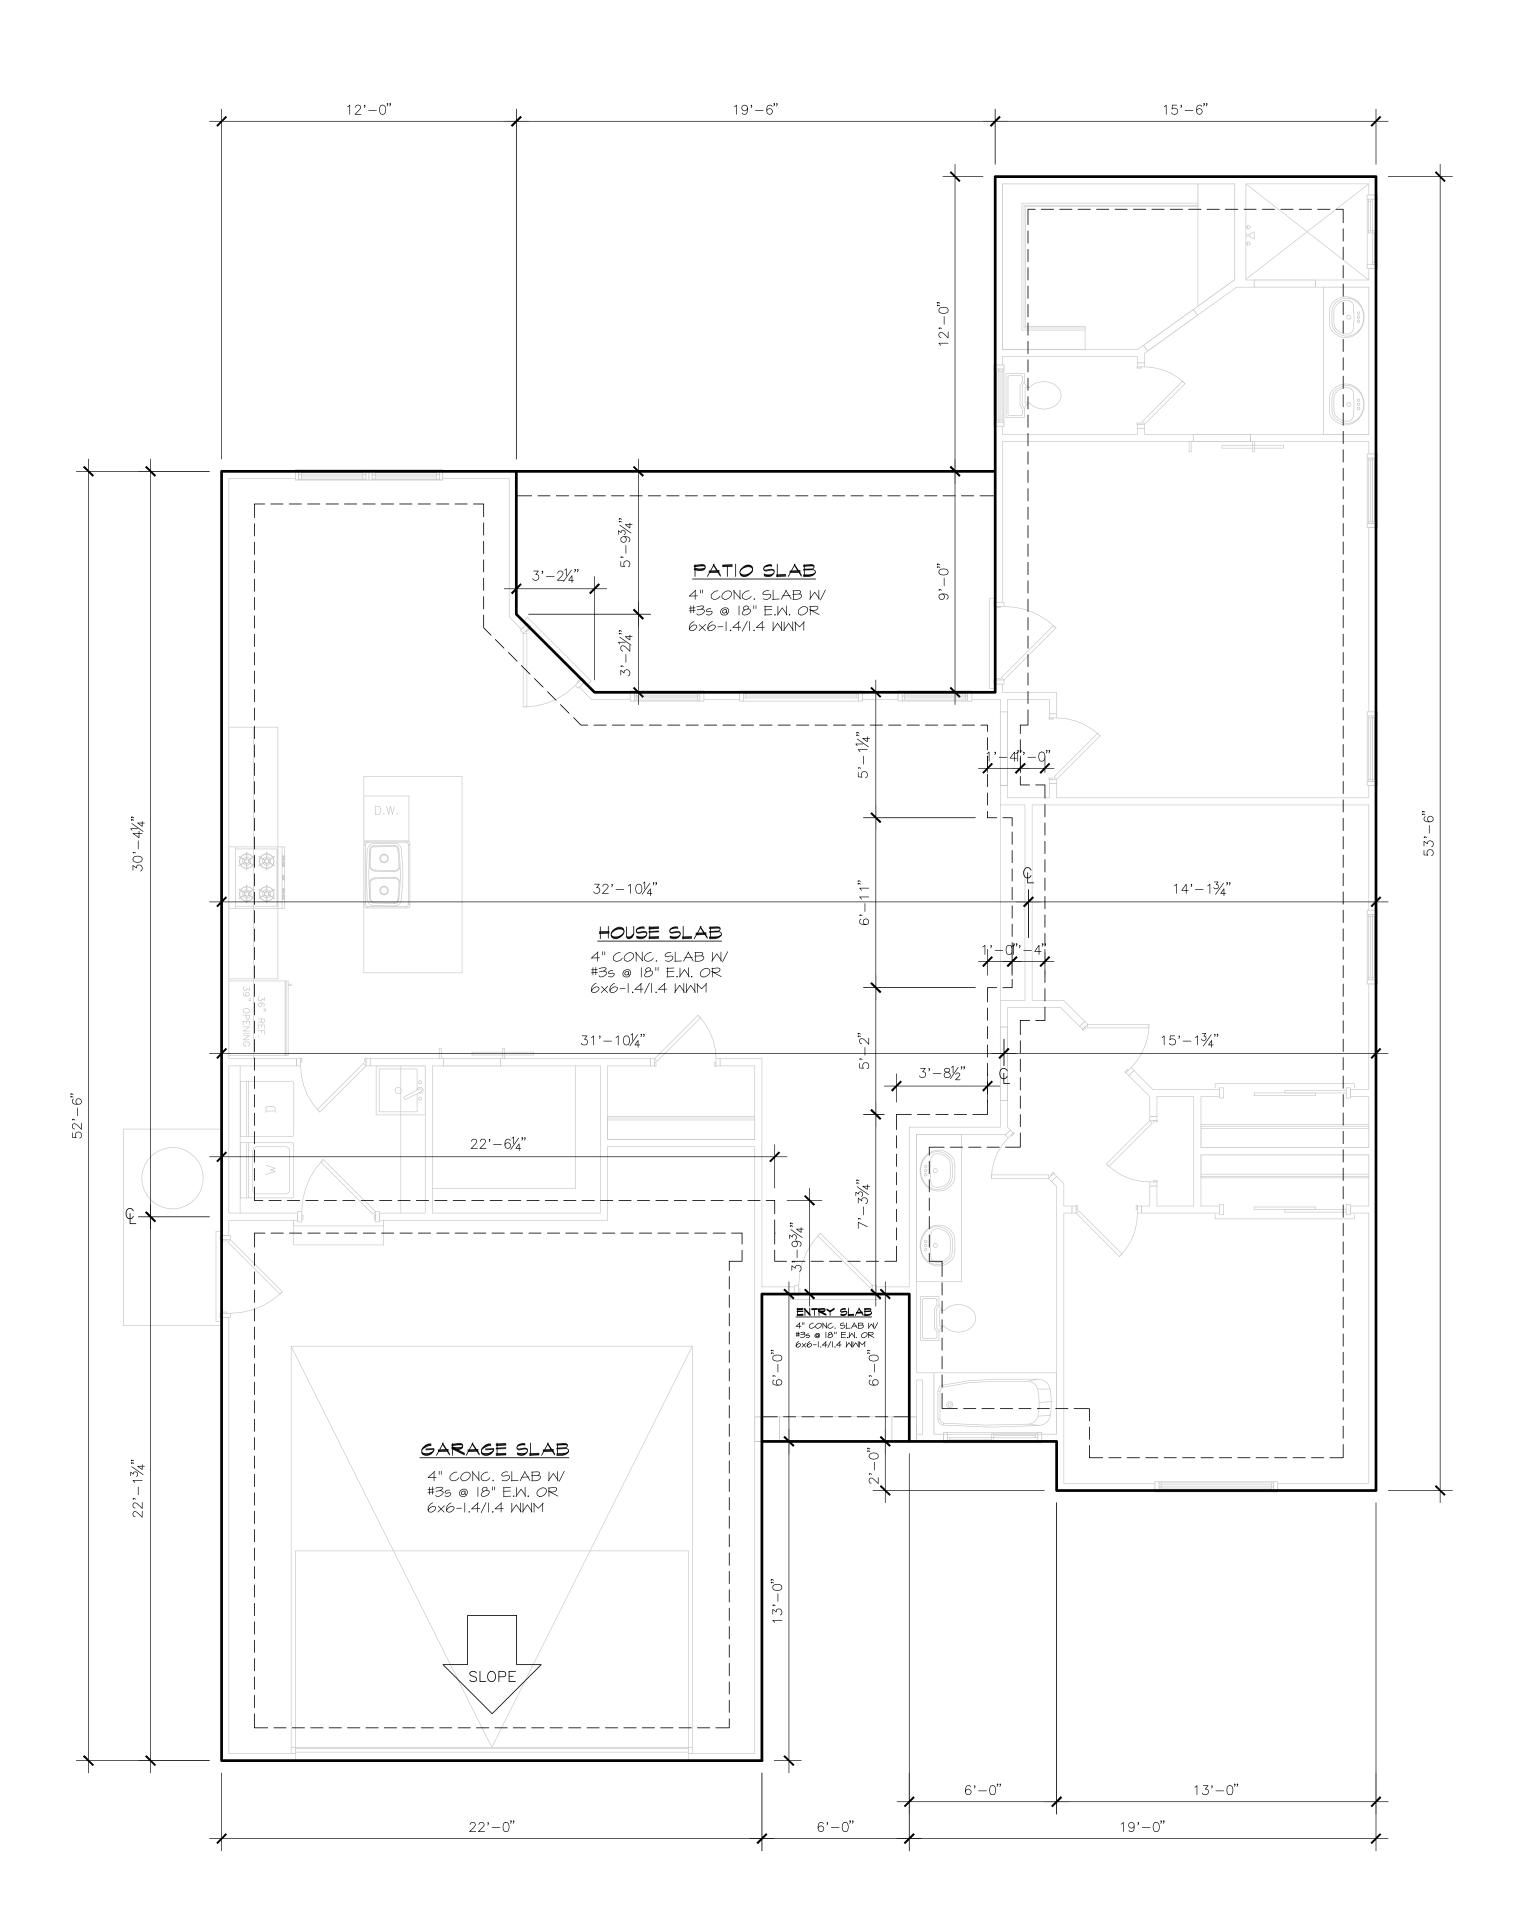


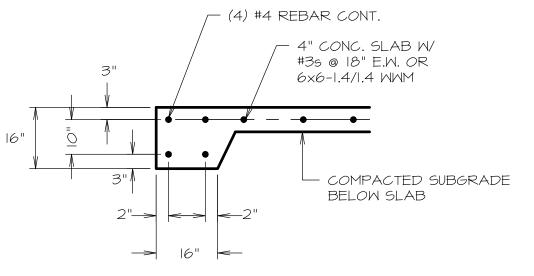


TYPICAL SLAB EDGE

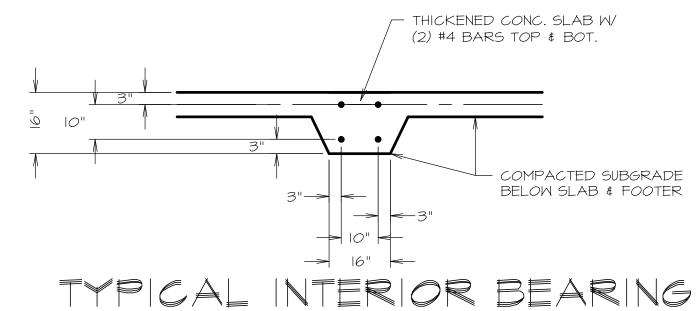

A 08-12-2020
B
C
D
E
F
G
H

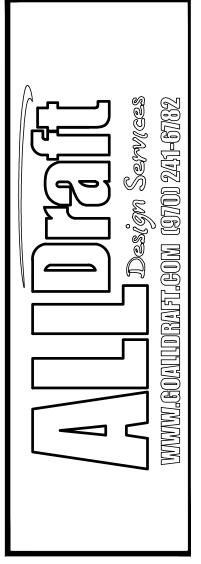

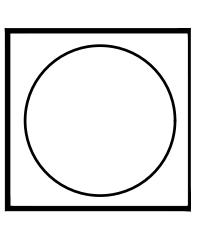

ASPEN LEAF ININOWATIONS
2909 ARABESQUE DRIVE
LOT 5 BLK 1 ARABESQUE SUE

DRAWN BY
ALLDRAFT
FILE NAME
CAD FILE
DATE
08-14-2020
SCALE
1/4" = 1'-0"
SHEET

COPY RIGHT NOTICE:

31. THE OWNER AND OR BUILDER AGREE TO OBTIAN A LICENSE FOR ANY COPY RIGHTED MATERIAL THAT AMY HAVE BEEN PROVIDED TO ALLDRAFT FOR THE CREATION OF THIS PLAN PRIOR TO CONSTRUCTION.

22. THE OWNER AND OR BUILDER AGREE TO RESEARCH AND VERIFY THE LEGALITY OF ALL COPY RIGHT WONNERSHIPS FOR ALL MATERIALS THAT THEY HAVE PROVIDED TO ALLDRAFT.

33. THE OWNER AND OR BUILDER AGREE THAT ALLDRAFT IS NOT RESPONSIBLE FOR OBTAINING ANY RIGHT LICENSE AND AGREE TO HOLD HARMLESS, DEFEND AND INDEMNIFY ALLDRAFT FROM

34. ANY AND ALL LEGAL ACTIONS THAT MAY RESULT FROM THE CREATION OF THESE PLANS.

4. USE OF THIS PLAN CONSTITUES ACCEPTANCE OF THESE TERMS BY THE OWNER AND OR BUILDER.